


RM050425 - BRASS DISK STAMPED "050425" LOCATED AT THE NORTHEAST CORNER OF THE BRIDGE ON RIO GRANDE OVER E127-00-00 ±60' SOUTH OF VILLAGE DRIVE IN KEY MAP 409L IN THE WHITE OAK BAYOU WATERSHED. ELEVATION = 104.75' (NAVD 88, 2001 ADJ.)


TEMPORARY BENCHMARKS:

TBM "A" - BOX CUT ON "BB" INLET LOCATED AT THE NORTHWEST CORNER OF SEATTLE STREE AND SENATE AVENUE. ELEVATION = 103.44'

TBM "B" - BOX CUT ON "BB" INLET LOCATED AT THE SOUTHWEST CORNER OF SEATTLE STREET AND CARLSBAD STREET. ELEVATION = 103.68'

TBM "C" - BOX CUT ON THE END OF THE CONCRETE SIDEWALK AT THE SOUND WALL LOCATED ON THE SOUTH SIDE OF SEATTLE STREET. ELEVATION = 106.16

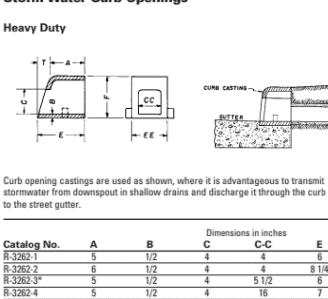

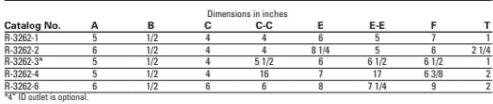



Rear view of R-3262-3 only.



STOR	M SEWI	ER DE	ETAILS

SEATTLE STREET RECONSTRUCTION PROJECT

16327 LAKEVIEW DR. JERSEY VILLAGE, TX 77040


DANTEL P. SIMFONE

AGUIRRE & FIELDS

ENGINEERING INNOVATOR

TBPE FIRM REGISTRATION # 739


			SHEET 1 OF 2
NO.	DATE	R	EVISIONS BY
DRA	WN BY:	TJR	APPROVED BY: CAH
DES	IGNED: [PS	DATE: 3/31/2022
SCA	LE:		SHEET: 25 OF 53

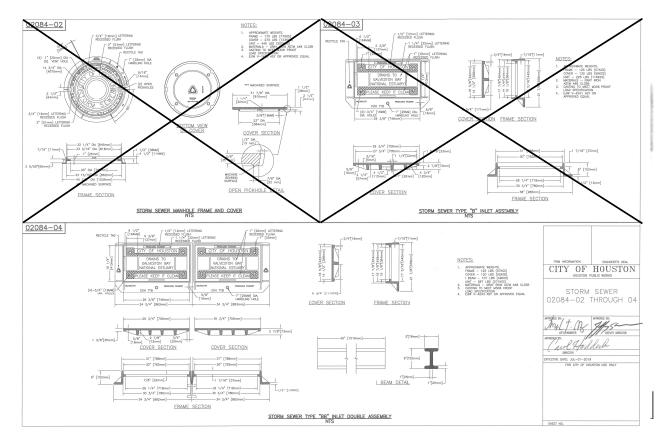


R-3262 Series Storm Water Curb Openings

Heavy Duty


to the street gutter.

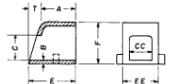

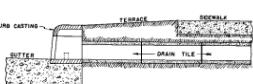

(optional)

N 5

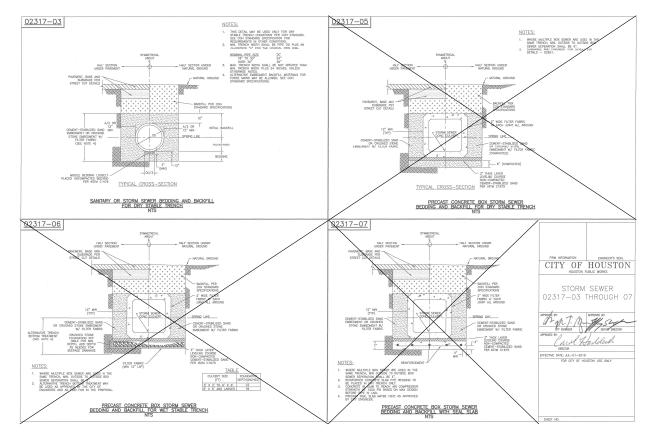

02632-06

AND GUTTER PVMT

1'-8" TYPE "C-1" 1'-10" TYPE "C-2A" 10'-0" TYPE "C-2A" 5'-0" TYPE "C-1"

ELEVATION

SECTION (A)


STORM SEWER TYPE "D" INLET

SECTION (C)

STORM SEWER TYPE "C-1", "C-2" AND "C-2A" INLET NTS

SECTION (A)

STORM SEWER TYPE "D-1" INLET

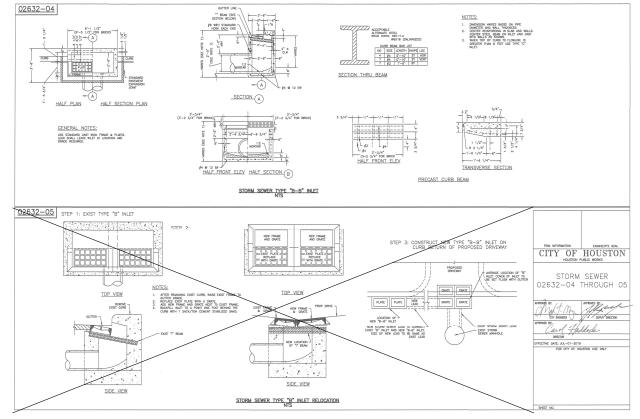



RM050425 - BRASS DISK STAMPED "050425" LOCATED AT THE NORTHEAST CORNER OF THE BRIDGE ON RIO GRANDE OVER E127-00-00 ±60' SOUTH OF VILLAGE DRIVE IN KEY MAP 409L IN THE WHITE OAK BAYOU WATERSHED. ELEVATION = 104.75' (NAVD 88, 2001 ADJ.)

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16327 LAKEVIEW DR. JERSEY VILLAGE, TX 77040



AGUIRRE & FIELDS

ENGINEERING INNOVATORS


1896 FIRM RECISTRATION # 739


SEATTLE STREET RECONSTRUCTION PROJECT

STORM SEWER DETAILS

SHEET 2

		SHEET 2 OF 2
NO. DAT	E R	REVISIONS BY
DRAWN B	Y: TJR	APPROVED BY: CAH
DESIGNED	: DPS	DATE: 3/31/2022
SCALE:		SHEET: 26 OF 53

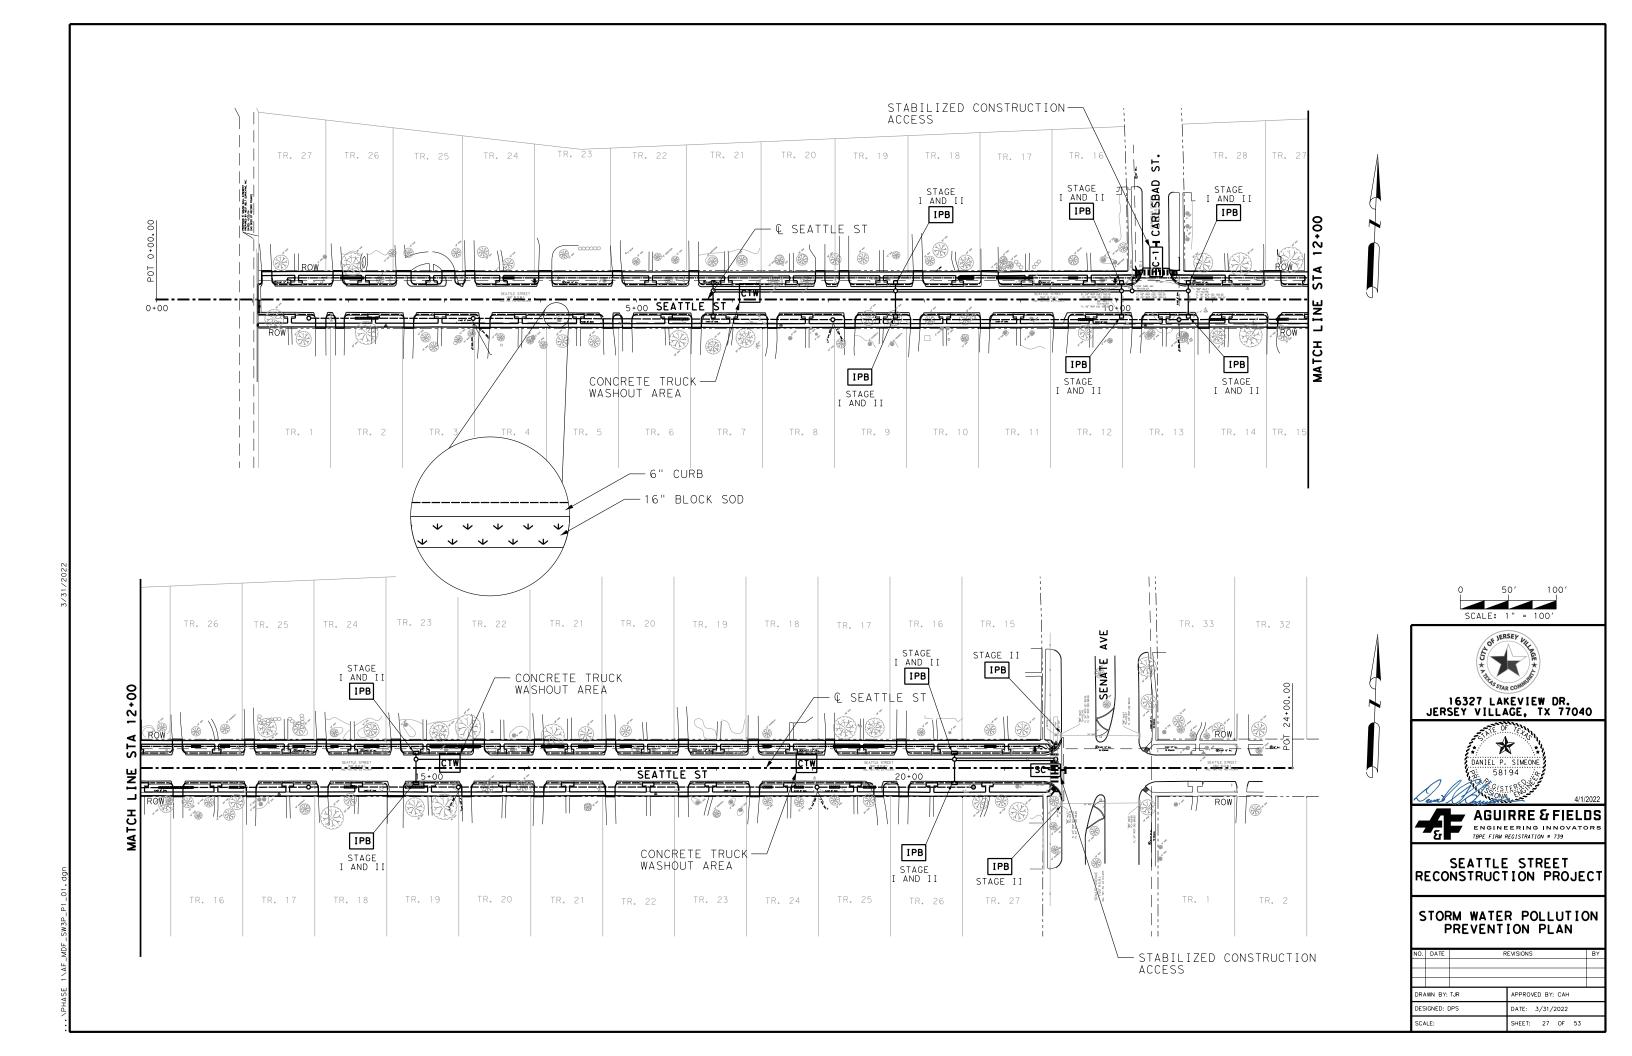

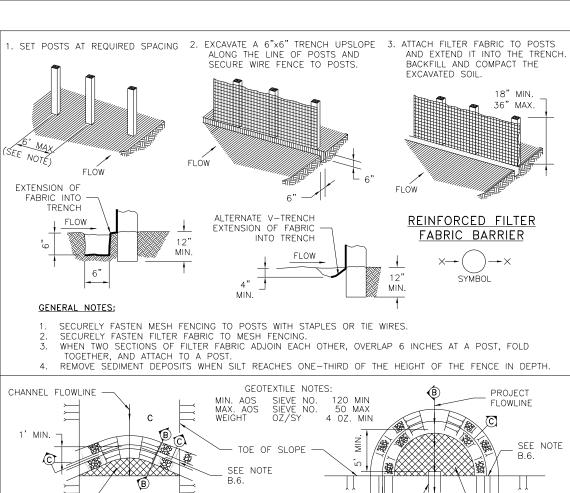

FILTER DAM

H(RFD-TYPE)

SYMBOL

VARIES

WITH TYPE

SEE NOTE

5' MIN.

NOTE: ONLY APPLIES FOR

PROTECTION.

DETENTION BASIN OUTFALL PIPE

VARIES

WITH TYPE

WIRE MESH (SEE NOTE B 1.)

SECTION B-B

SEE NOTE

WIRE MESE

SEE

GEOTEXTILE

a. HEIGHT — 18—24 INCHES. MEASURE VERTICALLY FROM

a. HEIGHT - 18-36 INCHES. MEASURE VERTICALLY FROM EXISTING GROUND TO TOP OF FILTER DAM.

a. HEIGHT - 36-48 INCHES. MEASURE VERTICALLY FROM

a. HEIGHT - 30 INCHES (MINIMUM). MEASURE VERTICALLY


FROM EXISTING GROUND TO TOP OF FILTER DAM.

EXISTING GROUND TO TOP OF FILTER DAM.

EXISTING GROUND TO TOP OF FILTER DAM.

(SEE NOTE B.1.)

LINER GEOTEXTILE **GENERAL NOTES:** FILTER DAM AT DETENTION BASIN OUTFALL PIPE VARIES PROPOSED WITH TYPE OR EXISTING NOTE A FLOWLINE -FLOW

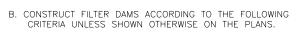

- 1. TYPE 2 AND 3 FILTER DAMS: SECURE WITH 20 GAUGE GALVANIZED WOVEN WIRE MESH WITH 1 INCH DIAMETER HEXAGONAL OPENINGS.
- 2. PLACE GRANULAR FILL ON THE WIRE MESH TO HEIGHT AND SLOPES SHOWN ON PLANS OR AS SPECIFIED BY THE ENGINEER
 - a. 3-5 INCHES FOR ROCK FILTER DAM TYPES 1, 2 AND 4. 4-8 INCHES FOR ROCK FILTER DAM TYPE REFER TO GRANULAR FILL IN SPECIFICATION SECTION No. 02378

GEOTEXTILE

NOTES

- RIPRAP AND GRANULAR FILL.
 3. FOLD WIRE MESH AT UPSTREAM SIDE OVER GRANULAR FILL AND TIGHTLY SECURED TO ITSELF ON THE DOWNSTREAM SIDE USING WIRE TIES OR HOG RINGS
- 4. IN STREAMS: SECURE OR STAKE MESH TO STREAM BED
- PRIOR TO AGGREGATE PLACEMENT.
- . SEE HCFCD SPECIFICATION SECTION NO. 02364-FILTER DAMS. 6. EMBED ONE FOOT MINIMUM INTO SLOPE AND RAISE ONE FOOT HIGHER THAN CENTER OF DEPRESSED AREA AT SLOPE



EXTENSION OF FABRIC INTO

COMPACTED

TRENCH

SOIL

FLOW

INLET

STAGE

WOOD OR

WOOD OR

VARIES

GENERAL NOTES:

METAL POST

METAL BEAM

AND I


SECTION A-A




15

<u>PLAN</u>



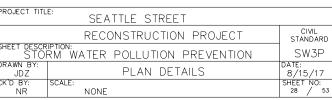

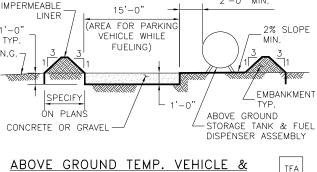


2'-0" MIN.

ABOVE GROUND TEMP. VEHICLE & EQUIPMENT FUELING AREA WITH TANK

GENERAL NOTES:


- 1. THE SIZE OF TANK FOUNDATION AREA DEPENDS ON THE SIZE OF ABOVE GROUND STORAGE TANK AND DISPENSER ASSEMBLY
- 2. PROVIDE A MINIMUM SLOPE OF 2 % TOWARD THE SUMP PIT. 3. INSTALL IMPERMEABLE LINER AS PER MANUFACTURER'S RECOMMENDATIONS.

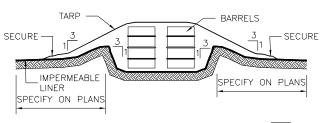

1. ALTERNATIVELY, STORE BARRELS IN AN ENCLOSED BUILDING OR SHED.

BARREL STORAGE AREA

- 2. INSTALL IMPERMEABLE LINER AS PER MANUFACTURER'S RECOMMENDATIONS. 60 mil MINIMUM.
- 3. CONSTRUCT BERMED AREA WITH VOLUME GREATER THAN OR EQUAL TO 110% VOLUME OF BARRELS

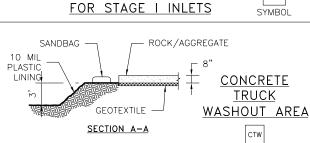

WOOD OR METAL BEAM -

(A)-

INLET PROTECTION BARRIER WITH REINFORCED FILTER FABRIC

INLET PROTECTION BARRIER
WITH FILTER ROLLS

1. FIBER ROLLS WILL BE UTILIZED ONLY WHEN SITE CONDITIONS DO NOT PERMIT THE USE OF FILTER FABRIC BARRIER, AND

INLET PROTECTION BARRIERS

FIBER ROLL

STAKED OR

WEIGHTED DOWN W/ GRAVEL BAGS

<u>PLAN</u>

COMPACTED SOIL

TO PREVENT PIPING

STAKED

FIBER ROLL

→ INLET

IPB

WOOD OR


METAL POST

1/3

<u>PLAN</u>

WELDED

WIRFOST

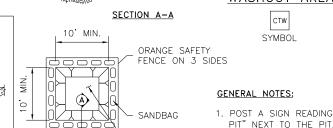

PLASTIC.

(8" THICK MIN.)

UNDERLAID WITH

GEOTEXTILE


1. POST A SIGN READING "CONCRETE WASHOUT

2. VERBALLY INSTRUCT THE CONCRETE TRUCK DRIVERS WHERE THE PIT IS AND TO WASHOUT THEIR TRUCKS IN THE PIT AND NOWHERE FLSE

3. UPON THE CONCRETE SETTING UP (CURING. DRYING OUT), THE CONCRETE WASTE SHALL BF RFMOVED FROM THE PROJECT SITE AND DISPOSED OF PROPERLY BY THE ROCK/AGGREGATE CONTRACTOR. AFTER REMOVAL OF CONCRETE WASTE, THE WASHOUT PIT SHALL BE FILLED WITH CLEAN FILL MATERIAL AND COMPACTED TO IN-SITU CONDITIONS, OR AS DIRECTED BY THE PROJECT SPECIFICATIONS.

4 CONCRETE WASHOUT PITS SHALL NOT BE LOCATED DIRECTLY ADJACENT TO, NOR AT ANY TIME DRAIN INTO THE STORM SEWER SYSTEM OR ANY OTHER SWALE, DITCH, OR WATERWAY

5. CONSTRUCT ENTRY ROAD AND BOTTOM OF WASHOUT AREA TO SUPPORT EXPECTED LOADINGS FROM TRUCKS EQUIPMENT.

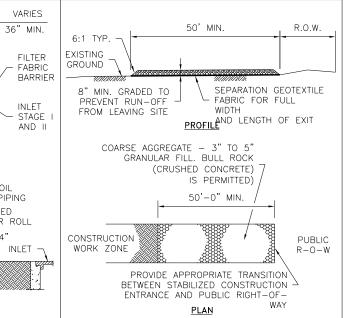

STABILIZED CONSTRUCTION ACCESS



GENERAL NOTES:

- . MINIMUM LENGTH IS AS SHOWN ON CONSTRUCTION DRAWINGS OR 50 FEET, WHICHEVER IS MORE.
- CONSTRUCT AND MAINTAIN CONSTRUCTION EXIT WITH CONSTANT WIDTH ACROSS ITS LENGTH, INCLUDING ALL POINTS OF INGRESS OR EGRESS
- 3. UNLESS SHOWN ON THE CONSTRUCTION DRAWINGS, STABILIZATION FOR OTHER AREAS WILL HAVE THE SAME AGGREGATE THICKNESS AND WIDTH REQUIREMENTS AS
- THE STABILIZED CONSTRUCTION EXIT. 4. WHEN SHOWN ON THE CONSTRUCTION DRAWINGS, WIDEN OR LENGTHEN STABILIZED AREA TO ACCOMMODATE A TRUCK WASHING AREA. PROVIDE OUTLET SEDIMENT TRAP FOR THE TRUCK WASHING
- PROVIDE PERIODIC TOP DRESSING WITH ADDITIONAL COARSE AGGREGATE TO MAINTAIN THE REQUIRED DEPTH OR WHEN SURFACE BECOMES PACKED WITH MUD.
- PERIODICALLY TURN AGGREGATE TO EXPOSE A CLEAN DRIVING SURFACE.
- 7. MINIMUM 14' WIDTH FOR ONE WAY TRAFFIC AND 20' WIDTH FOR TWO WAY TRAFFIC.

WOOD POST

3"x3"x8'

SCREW

PLYWOOD 48"x24"


4" HEIGHT

BLACK LETTERS

PAINTED WHITE

CONCRETE

WASHOUT PIT

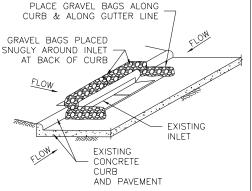


BSA

SYMB0

INLET PROTECTION BARRIERS IPB-II FOR STAGE II INLETS

GENERAL NOTES:

- 1. REMOVE SEDIMENT DEPOSIT WHEN THE SEDIMENT HAS ACCUMULATED TO ONE-THIRD THE HEIGHT OF THE BARRIER.
- . GRAVEL BAGS SHALL NOT BLOCK THROAT OF INLET UNLESS DIRECTED BY ENGINEER.

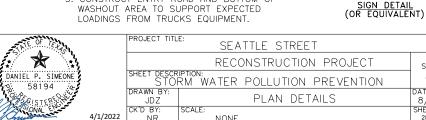

b. TOP WIDTH - 2 FEET (MINIMUM) 5. TYPE 5. AS SHOWN ON THE PLANS NO DATE NAME

IN-CHANNEL FILTER DAM

PLAN

SECTION C-C

1. TYPE 1 (NON-REINFORCED)

2. TYPE 2 (REINFORCED).

3. TYPE 3 (REINFORCED)

4. TYPE 4 (GABION)

b. TOP WIDTH - 2 FEET (MINIMUM)

b. TOP WIDTH - 2 FEET (MINIMUM).

b. TOP WIDTH - 2 FEET (MINIMUM).

c. SLOPES - 2:1 (MAXIMUM)

c. SLOPES - 2:1 (MAXIMUM).

c. SLOPES - 3:1 (MAXIMUM).

DEPRESS

NOTE


GRANULAR

CENTER

SEEREA I

A. TYPES OF FILTER DAMS

HARRIS COUNTY ENGINEERING DEPARTMEN

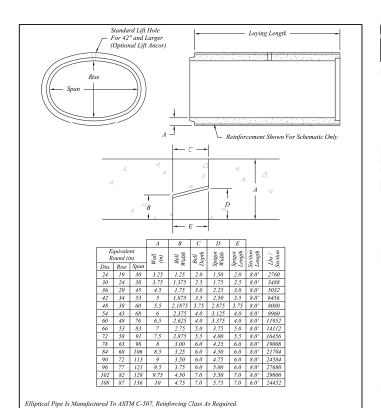

401 Kelton St Bay City, MI 48706 36" to 108" Precast Concrete Elliptical Pipe Detail

BmG NTS 01.03

 $Elliptical\ Pipe\ Is\ Independently\ Air\ \&\ Hydrostatic\ Tested.$

4950 White Lake Rd Clarkston, MI 48346

6



ELLIPTICAL CONCRETE PIPE





EQUIVALENT ROUND SIZE (INCHES)	HEIGHT INSIDE (INCHES)	WIDTH INSIDE (INCHES)	WALL THICKNESS (INCHES)	WATERWAY AREA (SQ. FT.)	WEIGHT POUNDS PER FOOT
18	14	23	23/,	1.8	211
24	19	30	31/,	3.3	319
30	24	38	33/,	5.1	452
36	29	45	41/2	7.4	625
42	34	23	5	10.2	853
48	38	60	51/,	12.9	1,061
54	43	68	6	16.6	1,235
60	48	76	61/2	20.5	1,475
72	58	91	71/2	29.5	2,040
84	68	106	81/2	40.1	2,680

Horizontal elliptical concrete pipe offers the hydraulic advantage of greater capacity for the same depth of flow than most other structures of equivalent water way area.

Elliptical concrete pipe (C-507) carries approximately 25% more water than concrete arch pipe (C-506) due to the greater water way area and hydraulic radius. Elliptical pipe has a slightly greater capacity than round pipe.

The term "round equivalent" is a misnomer, and elliptical and arch pipe should not be considered equal alternates. The designer may refer to the "concrete pipe design manual" for flow coefficient values.

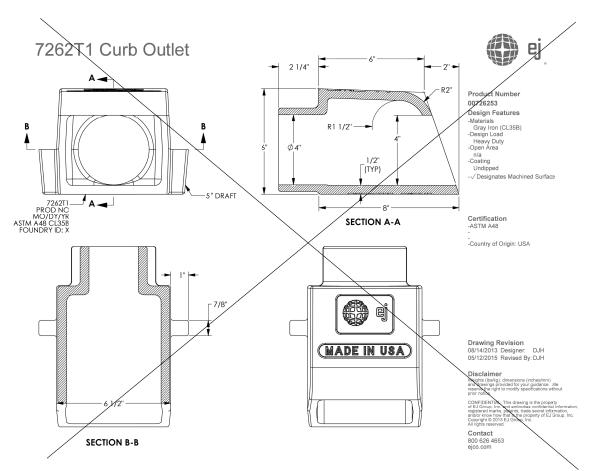

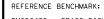

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16327 LAKEVIEW DR. JERSEY VILLAGE, TX 77040




AGUIRRE & FIELDS
ENGINEERING INNOVATORS
THE FIRM RECISTRATION = 739

SEATTLE STREET
RECONSTRUCTION PROJECT

MISCELANEOUS DETAILS

NO.	DATE	R	EVISIONS				BY
DRAWN BY: TJR		APPROV	ED BY	CAH			
DESIGNED: DPS		DATE:	3/31/	2022			
SCALE:			SHEET:	29	OF	53	

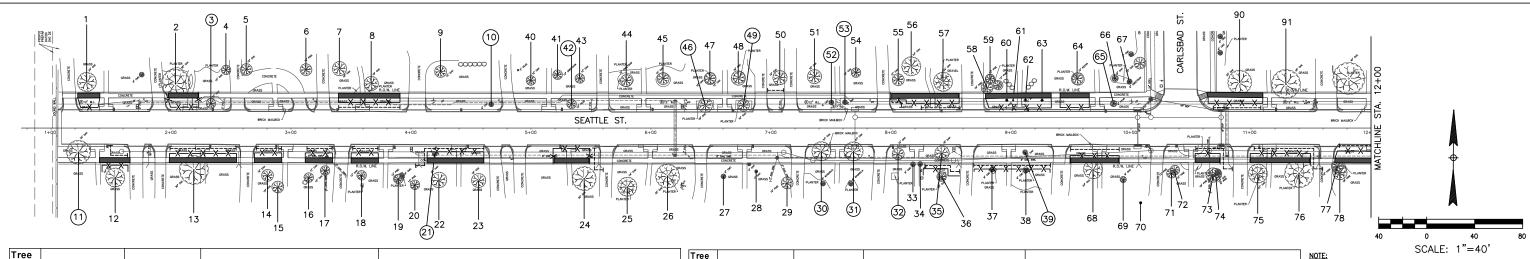

91 16126 Seattle Street tree no longer there

ee).	Location	Description	Comments	Treatment
	on Seattle Street			
1	16246 Seattle Street	26" Live Oak	Private tree	Demo-form-pour walk without damage to tree roots 1" diameter or larger, Fence
				Bore waterline, Demo-form-pour walk without damage to tree roots 1" diameter
2	16242 Seattle Street	45" Arizona Ash	50% dieback, Private tree	larger, Fence
			Poor condition, 50% of canopy gone, Remove	
2	16242 Seattle Street	15" Prodford Poor	for street widening and stabilization back of curb	Pomoun troo
	16242 Seattle Street	16" Green Ash	Private tree, Not impacted	Remove tree
	16238 Seattle Street		Private tree, Not impacted	
	16238 Seattle Street		Private tree, Not impacted	
		21" Live Oak	Private tree, Not impacted	
	10254 Seattle Street	ZT ENG GAR	Titlato troe, Not impaoted	Root prune for street, Bore waterline, Demo-form-pour walk without damage to
8	16234 Seattle Street	24" Live Oak	Private tree	roots 1" diameter or larger, Fence, Clearance prune
		15" Live Oak	Private tree, Not impacted	
			Topped, Scale insects, Black sooty mold, Poor	
			condition, Remove for street widening and	
	16230 Seattle Street		stabilization back of curb	Remove tree
11	16245 Seattle Street	27" Water Oak	Good condition, Remove for street widening	Remove tree
		4011 14/-1 - 0 - 1	B. states	Root prune for manhole and sanitary bore pit, Demo-form-pour walk without
12	16245 Seattle Street	18" Water Oak	Private tree	damage to tree roots 1" diameter or larger, Fence, Clearance prune
12	16241 Coattle Street	35" Arizona Ash	Private tree	Bore sanitary, Root prune for street, Demo-form-pour walk without damage to to roots 1" diameter or larger, Fence, Clearance prune
13	16241 Seattle Street	33 Alizolia Asii	r iivate tree	Root prune for sanitary open cut trench, Demo-form-pour walk without damage
14	16237 Seattle Street	16" Water Oak	Private tree	tree roots 1" diameter or larger, Fence
15	16237 Seattle Street	15" Water Oak	Private tree, Not impacted	
	16237 Seattle Street		Private tree	Clearance prune
	10257 Scattie Street			Root prune for sanitary open cut trench, Demo-form-pour walk without damage
17	16237 Seattle Street	15" Water Oak	Private tree	tree roots 1" diameter or larger, Fence
				Root prune for sanitary open cut trench, Demo-form-pour walk without damage
18	16233 Seattle Street	13" Live Oak	Private tree	tree roots 1" diameter or larger, Fence
19	16233 Seattle Street	14" Pine	Private tree, Not impacted	
20	16233 Seattle Street	11" Pine	Private tree, Not impacted	
			Remove for street widening and stabilization	
21	16229 Seattle Street	5" Стере мупіе	back of curb	Remove tree
22	16229 Seattle Street	20" Live Oak	Private tree	Root prune for sanitary open cut trench, Demo-form-pour walk without damage tree roots 1" diameter or larger, Fence
	10229 Seattle Street	20 Live Oak	r iiwate tiee	Root prune for sanitary open cut trench, Demo-form-pour walk without damage
23	16229 Seattle Street	22" Live Oak	Private tree	tree roots 1" diameter or larger, Fence
				Root prune for water service lead, Bore sanitary, Demo-form-pour walk without
		25" Live Oak	Private tree	damage to tree roots 1" diameter or larger, Fence
25	16221 Seattle Street	24" Live Oak	Private tree, Not impacted	
00	10004 0	00111: 0-1-	Private tree, Very large limb tear wound with	
	16221 Seattle Street Not available	28" Live Oak 6" Crepe Myrtle	decay on trunk, Poor condition, Not impacted Private tree, Not impacted	
	Not available	2" Water Oak	Private tree, Not impacted	
	16213 Seattle Street	16" Pine	Private tree, Not impacted	
			Good condition, Remove for street widening and	
30	16213 Seattle Street	26" Live Oak	manhole	Remove tree
			Good condition, Remove for street widening and	
	16213 Seattle Street	24" Live Oak	BB inlet construction	Remove tree
32	16209 Seattle Street	17" Live Oak	Good condition, Remove for street widening Topped, Poor condition, Private tree, not	Remove tree
33	16209 Seattle Street	4" Crepe Myrtle	impacted	
			Topped, Poor condition, Private tree, not	
		4" Crepe Myrtle	impacted	
		20" Live Oak	Good condition, Remove for street widening	Remove tree
	16209 Seattle Street	12" Nuttal Oak	Private tree	Root prune for sanitary open cut, Fence
	16205 Seattle Street	21" Crepe Myrtle	Private tree	Root prune for sanitary open cut, Fence, Clearance prune
38	16205 Seattle Street	21" Crepe Myrtle	Private tree	Root prune for sanitary open cut, Fence, Clearance prune
			Poor condition, 50% of canopy gone, Remove for street widening and stabilization back of	
00	16205 Contillo Stroot	6" Shumard Oak	curb	Remove tree

	Tree No.	Location	Description	Comments	Treatment
1		on Seattle Street			Trouble to the second s
+		16226 Seattle Street	11" Live Oak	Private tree, Not impacted	
		16226 Seattle Street	18" Nuttal Oak	Private tree, Not impacted	
	41	10220 Seattle Street	10 INULIAI OAK	Remove for street widening and stabilization	
	42	16226 Seattle Street	15" Callery Pear	back of curb	Remove tree
		16226 Seattle Street	14" Live Oak	Private tree, Not impacted	
		16222 Seattle Street	17" Arizona Ash	Private tree, Not impacted	
		16222 Seattle Street	15" Arizona Ash	Private tree, Not impacted	
		16218 Seattle Street	21" Live Oak	Good condition, Remove for street widening	Remove tree
		16218 Seattle Street	18" Water Oak	Private tree, Not impacted	Nome to the
		16218 Seattle Street	17" Water Oak	Private tree, Not impacted	
		16218 Seattle Street	18" Live Oak	Good condition, Remove for street widening	Remove tree
		16218 Seattle Street	21" Live Oak		
				Private tree	Root prune for waterline, Clearance prune
	51	16214 Seattle Street	19" Arizona Ash	30% dieback, Private tree, poor	Clearance prune
	52	16214 Seattle Street	4" Crepe Myrtle	Remove for street widening and stabilization back of curb	Remove tree
	- 5 2	102 17 Ocallie Glieel	- Oropo Wigitio	Remove for street widening and stabilization	Tomovo troo
	FO	16214 Coottle Ctreet	9" Cropo Murtis		Pomoun trop
		16214 Seattle Street	8" Crepe Myrtle	back of curb	Remove tree
	54	16214 Seattle Street	12" Live Oak	Private tree, Not impacted	Pool as no forward discribers with Domo forward in the state of the st
	l _				Root prune for waterline/bore pit, Demo-form-pour walk without damage to tree
		16210 Seattle Street	15" Water Oak	Private tree	roots 1" diameter or larger, Fence, Clearance prune
	56	16210 Seattle Street	27" Willow Oak	Private tree, Not impacted	
					Root prune for street, Bore waterline, Demo-form-pour walk without damage to tre
	57	16210 Seattle Street	26" Live Oak	Private tree	roots 1" diameter or larger, Fence, Clearance prune
					Bore waterline, Demo-form-pour walk without damage to tree roots 1" diameter of
	58	16206 Seattle Street	19" Pine	Private tree	larger, Fence
					Bore waterline, Demo-form-pour walk without damage to tree roots 1" diameter or
	59	16206 Seattle Street	14" Pine	Private tree	larger, Fence
	- 3				Bore waterline, Demo-form-pour walk without damage to tree roots 1" diameter or
	60	16206 Spattle Street	3" Crana Murtia	Topped Poor condition	
	- 00	16206 Seattle Street	o crepe iviyitie	Topped, Poor condition	larger, Fence
		1,0000 0	# O D . l		Bore waterline, Demo-form-pour walk without damage to tree roots 1" diameter or
	61	16206 Seattle Street	4' Sago Palm	1	larger, Fence
	_	l	L		Bore waterline, Demo-form-pour walk without damage to tree roots 1" diameter of
	62	16206 Seattle Street	5" Juniper		larger, Fence
					Bore waterline, Demo-form-pour walk without damage to tree roots 1" diameter or
	63	16206 Seattle Street	3" Crepe Myrtle		larger, Fence
					Bore waterline, Demo-form-pour walk without damage to tree roots 1" diameter or
	64	16206 Seattle Street	18" Pecan	Private tree	larger, Fence
				Remove for street widening and stabilization	•
	65	16202 Seattle Street	9" Crabapple	back of curb	Remove tree
		16202 Seattle Street	13" Bur Oak	Private tree, Not impacted	
		16202 Seattle Street	9" Bur Oak	Private tree, Not impacted	
	<u> </u>	10202 Seattle Stieet	5 Dui Oak	i mate tree, not impacted	Poro sanitany Poot name for street. Dome form near walk without demand to tree
		Not eveilable	OC! Nuttel Oc!	Britata traa	Bore sanitary, Root prune for street, Demo-form-pour walk without damage to tree
		Not available	26" Nuttal Oak	Private tree	roots 1" diameter or larger, Fence, Clearance prune
		Not available	9" Mulberry	Private tree, Not impacted	
			27" Water Oak	Private tree, Not impacted	
		16129 Seattle Street	10" Pine	Private tree, Not impacted	
	72	16129 Seattle Street	11" Pine	Private tree, Not impacted	
	70	16120 Coottle Ctre -1	14" Dino	Driveto tree	Root prune for sanitary open cut trench, Demo-form-pour walk without damage to
	/3	16129 Seattle Street	14" Pine	Private tree	tree roots 1" diameter or larger, Fence
		l	l	L	Root prune for sanitary open cut trench, Root prune for sanitary lead, Demo-form
	74	16129 Seattle Street	16" Live Oak	Private tree	pour walk without damage to tree roots 1" diameter or larger, Fence
					Bore sanitary, Root prune for street, Demo-form-pour walk without damage to tree
	75	16125 Seattle Street	31" Live Oak	Private tree	roots 1" diameter or larger, Fence, Clearance prune
					Root prune for sanitary lead, Bore sanitary, Root prune for street, Demo-form-po
	76	16125 Seattle Street	44" Live Oak	Private tree	walk without damage to tree roots 1" diameter or larger, Fence, Clearance prune
					Bore sanitary, Root prune for street, Demo-form-pour walk without damage to tree
	77	16121 Seattle Street	19" Pine	Private tree	roots 1" diameter or larger, Fence
			<u> </u>	1	Bore sanitary, Root prune for street, Demo-form-pour walk without damage to tree
	79	16121 Seattle Street	21" Pine	Private tree	roots 1" diameter or larger, Fence
	<u> </u>	10121 Oballie Gliebl	21 11110	i nvato tree	Root prune for street, Bore waterline, Demo-form-pour walk without damage to tre
		16126 Coottle Ct	20" Motor Oak	Drivate tree	
	90	16126 Seattle Street	∠ə vvater ∪ak	Private tree	roots 1" diameter or larger, Fence
		140400 0 111 - 01 1	Hann on Income Occur-	T. Control of the Con	1

NOTE:

1. THIS TREE PROTECTION PLAN WAS DEVELOPED WITH INFORMATION PROVIDED BY DESIGN ENGINEER IN DRAWINGS DATED OCTOBER 2021. THE PLAN CONSIDERS ALL FITTINGS, VERTICAL OFFSETS AND AREAS OF NECESSARY EXCAVATION. CHANGES MADE TO DESIGN MAY COMPROMISE THE TREE PROTECTION PLAN. REFER SPECIFICATIONS ON TPP 4 OF 4. CONDITION OF EACH TREE IS BASED ON VISUAL EVALUATION AT TIME OF DESIGN. CONDITION AND STRUCTURAL INTEGRITY OF EACH TREE IS NOT GUARANTEED BY DESIGNER AT ANY POINT IN THE FUTURE, AS ENVIRONMENTAL AND MAINTENANCE INFLUENCES ON EACH TREE CAN NOT BE DETERMINED BY DESIGNER.

 IN AREAS WHERE INDIVIDUAL TREES HAVE NOT BEEN TIED IN BY SURVEY APPROXIMATE LOCATION IS INDICATED ON TPP. ACCURACY OF REPRESENTED LOCATION CANT, AND IS NOT GUARANTEED BY DESIGNER.

TREE PRESERVATION PLAN LEGEND

1

TREE NUMBER/LOCATION TREE TO BE REMOVED

-X--X-

TREE PROTECTION FENCE +---- ROOT PRUNING TRENCH

16327 LAKEVIEW DR. JERSEY VILLAGE, TX 77040

C.N. Koehl


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210 Stone Bush Ct. . Katy, Texas 77493 281-391-0022 ckoehl@koehlurbanforestrv.com APPROVED Craig N. Kooll 11-08-2021

SEATTLE STREET RECONSTRUCTION PROJECT


TREE PROTECTION PLAN SHEET 1 OF 4

DATE	REVISIONS				BY		
DRAWN BY: N.B.			APPROVED BY: C.N.K.				
DESIGNED: C.N.K.			DATE: 11-08-2021				
SCALE:			29	OF	52		
	WN BY:	WN BY: N.B.	WN BY: N.B. APPRO	WN BY: N.B. APPROVED BY: IGNED: C.N.K. DATE: 11-08-	WN BY: N.B. APPROVED BY: C.N.K. IGNED: C.N.K. DATE: 11-08-2021	WN BY: N.B. APPROVED BY: C.N.K. IGNED: C.N.K. DATE: 11-08-2021	

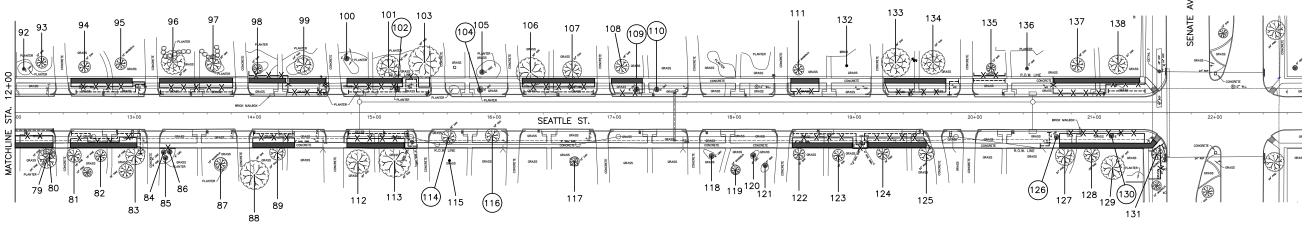

138 16002 Seattle Street 23" Laurel Oak

Private tree

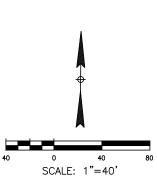

Tree				
No.	Location	Description	Comments	Treatment
Trees	on Seattle Street	i i		
			Recent excavation between tree and home has	Bore sanitary, Root prune for street, Demo-form-pour walk without damage to tree
79	16121 Seattle Street	26" Pine	impacted tree, Private tree	roots 1" diameter or larger, Fence
				Bore sanitary, Root prune for street, Demo-form-pour walk without damage to tree
80	16121 Seattle Street	19" Pine	Private tree	roots 1" diameter or larger, Fence
				Bore sanitary, Root prune for street, Demo-form-pour walk without damage to tree
81	16117 Seattle Street	20" Pine	Private tree	roots 1" diameter or larger, Fence
				Root prune for manhole and sanitary bore pit, Demo-form-pour walk without
82	16117 Seattle Street	19" Pine	Private tree	damage to tree roots 1" diameter or larger, Fence
				Root prune for sanitary lead, Bore sanitary, Root prune for street, Demo-form-pou
	16117 Seattle Street		Private tree	walk without damage to tree roots 1" diameter or larger, Fence
	16113 Seattle Street		Private tree	Fence, Clearance prune
	16113 Seattle Street		Private tree	Fence, Clearance prune
	16113 Seattle Street		Private tree	Fence, Clearance prune
	16113 Seattle Street		Private tree, Not impacted	
88	Not available	37" Live Oak	Private tree, Not impacted	
		071111		Bore sanitary, Root prune for street, Demo-form-pour walk without damage to tree
	Not available	27" Live Oak	Private tree	roots 1" diameter or larger, Fence, Clearance prune
	16122 Seattle Street		Private tree, Not impacted	
93	16122 Seattle Street	20" Magnolia	Private tree, Not impacted	
٠.,				Root prune for street, Bore waterline, Demo-form-pour walk without damage to tree
94	16118 Seattle Street	26" Water Oak	Private tree	roots 1" diameter or larger, Fence
۰,	10110 0	47" M	050/ dishark Fair and dishar Drivet to a	Root prune for street, Root prune for water tap&lead, Bore waterline, Demo-form-
95	16118 Seattle Street	17" Magnolia	25% dieback, Fair condition, Private tree	pour walk without damage to tree roots 1" diameter or larger, Fence Root prune for street, Bore waterline, Demo-form-pour walk without damage to tree
06	16114 Seattle Street	22" Live Ook	Driveto trop	roots 1" diameter or larger, Fence
96	10114 Seattle Street	32 Live Oak	Private tree	Root prune for street, Bore waterline, Demo-form-pour walk without damage to tree
97	16114 Seattle Street	27" Live Oak	Private tree	roots 1" diameter or larger, Fence
- 37	10114 Ocaliic Olicci	Z7 LIVE OUR	I mate tree	Bore waterline, Demo-form-pour walk without damage to tree roots 1" diameter or
98	16110 Seattle Street	15" Magnolia	Private tree	larger, Fence
	TOTTO COUNTY CHOCK	10 Magnona	T THAT GO	Bore waterline, Demo-form-pour walk without damage to tree roots 1" diameter or
99	16110 Seattle Street	27" Nutall Oak	Private tree	larger, Fence
	16110 Seattle Street		Private tree, Not impacted	g,
		. ,	·	Root prune for street, Bore waterline, Demo-form-pour walk without damage to tree
101	16106 Seattle Street	33" Live Oak	Private tree	roots 1" diameter or larger, Fence
			Remove for street widening and stabilization	
102	16106 Seattle Street	8" Crepe Myrtle	back of curb	Remove tree
				Root prune for street, Bore waterline, Root prune for fire hydrant-tee&valve, Demo-
103	16102 Seattle Street	36" Live Oak	Private tree	form-pour walk without damage to tree roots 1" diameter or larger, Fence
			Remove for street widening and stabilization	
	16102 Seattle Street		back of curb	Remove tree
105	16102 Seattle Street	9" Loquat	Private tree, Not impacted	
				Root prune for street, Bore waterline, Demo-form-pour walk without damage to tree
106	16026 Seattle Street	34" Live Oak	Private tree	roots 1" diameter or larger, Fence, Clearance prune
				Root prune for street, Bore waterline, Demo-form-pour walk without damage to tree
107	16026 Seattle Street	25" Live Oak	Private tree	roots 1" diameter or larger, Fence, Clearance prune
	10000 0	400.04.4.	D	Bore waterline, Demo-form-pour walk without damage to tree roots 1" diameter or
108	16022 Seattle Street	ן זא∵ Water Oak	Private tree	larger, Fence

Tree				
No.	Location	Description	Comments	Treatment
Trees	on Seattle Street	·		
			Topped, Remove for street widening and	
109	16022 Seattle Street	8" Crepe Myrtle	stabilization back of curb	Remove tree
		<u> </u>	Topped, Remove for street widening and	
110	16022 Seattle Street	10" Crepe Myrtle	stabilization back of curb	Remove tree
				Bore waterline, Demo-form-pour walk without damage to tree roots 1" diameter or
111	16014 Seattle Street	14" Magnolia	Private tree	larger, Fence
		,		Bore sanitary, Root prune for street, Demo-form-pour walk without damage to tree
112	16105 Seattle Street	36" Live Oak	Private tree	roots 1" diameter or larger, Fence
				Root prune for manhole and sanitary bore pit, Root prune for street, Demo-form-
				pour walk without damage to tree roots 1" diameter or larger, Fence, Clearance
113	16105 Seattle Street	34" Live Oak	Private tree	prune
			Topped, Poor condition, Remove for street	
114	Not available	22" Bradford Pear	widening and stabilization back of curb	Remove tree
115	Not available	18" Cedar Elm	Private tree, Not impacted	
			Topped, Poor condition, Remove for street	
116	Not available	22" Bradford Pear	widening and stabilization back of curb	Remove tree
			Trunk cankers, Poor condition, Private tree, Not	
117	16025 Seattle Street	11" Nutall Oak	impacted	
118	16017 Seattle Street	10" Crepe Myrtle	Private tree, Not impacted	
119	16017 Seattle Street	14" Magnolia	Private tree, Not impacted	
120	16017 Seattle Street	8" Crepe Myrtle	Topped, Private tree, not impacted	
121	16017 Seattle Street	11" Crepe Myrtle	Topped, Private tree, not impacted	
				Bore sanitary, Root prune for street, Demo-form-pour walk without damage to tree
122	16013 Seattle Street	23" Water Oak	Private tree	roots 1" diameter or larger, Fence
				Bore sanitary, Root prune for street, Root prune for water service lead, Demo-form-
123	16013 Seattle Street	17" Water Oak	Private tree	pour walk without damage to tree roots 1" diameter or larger, Fence
				Bore sanitary, Root prune for street, Root prune for water service lead, Demo-form-
124	16009 Seattle Street	19" Pine	Private tree	pour walk without damage to tree roots 1" diameter or larger, Fence
				Bore sanitary, Root prune for street, Demo-form-pour walk without damage to tree
125	16009 Seattle Street	23" Pine	Private tree	roots 1" diameter or larger, Fence
			Remove for street widening and stabilization	
126	16001 Seattle Street	9" Crepe Myrtle	back of curb	Remove tree
				Root prune for sanitary lead, Demo-form-pour walk without damage to tree roots 1"
	16001 Seattle Street		Private tree	diameter or larger, Fence
	16001 Seattle Street		Private tree	Demo-form-pour walk without damage to tree roots 1" diameter or larger, Fence
129	16001 Seattle Street	28" Water Oak	Private tree	Demo-form-pour walk without damage to tree roots 1" diameter or larger, Fence
			Topped, Poor condition, Remove for street	
130	16001 Seattle Street	8" Crepe Myrtle	widening and stabilization back of curb	Remove tree
			Topped by overhead utility, 50% dieback, Poor	Root prune for street, Demo-form-pour walk without damage to tree roots 1"
	16001 Seattle Street		condition	diameter or larger, Fence
132	16014 Seattle Street	8" Live Oak	Private tree, Not impacted	
				Bore waterline, Demo-form-pour walk without damage to tree roots 1" diameter or
133	16010 Seattle Street	37" Water Oak	20% dieback, Private tree	larger, Fence
,				Root prune water tap & lead, Bore waterline, Demo-form-pour walk without
	16010 Seattle Street		Private tree	damage to tree roots 1" diameter or larger, Fence
	16006 Seattle Street		Private tree	Root prune for waterline open cut, Fence, Clearance prune
136	16006 Seattle Street	6" Live Oak	Private tree, Not impacted	Book to the Book for the state of the state
1	10000 0 111 - 0:	001111111111111111111111111111111111111	D. data	Bore waterline, Demo-form-pour walk without damage to tree roots 1" diameter or
137	16002 Seattle Street	∠∪ Water Oak	Private tree	larger, Fence



16327 LAKEVIEW DR. JERSEY VILLAGE, TX 77040

C.N. Koehl

Urban Forestry, Inc.

Root prune waterline bends and bore pit, Demo-form-pour walk without damage to

tree roots 1" diameter or larger, Fence, Clearance prune

210 Stone Bush Ct. · Katy, Texas 77493 281-391-0022 ckoehl@koehlurbanforestry.com APPROVED Cong. N. Koult. 11-08-2021

SEATTLE STREET RECONSTRUCTION PROJECT

TREE PROTECTION PLAN SHEET 2 OF 4

NO.	DATE	REVISIONS					BY
_						_	_
-							_
DRA	WN BY:	N.B.	APPRO				
DES	DESIGNED: C.N.K.			11-08-	2021		
SCA	SCALE:			330	OF	52	

TREE PRESERVATION PLAN LEGEND

TREE NUMBER/LOCATION TREE TO BE REMOVED

-X-X- TREE PROTECTION FENCE


ROOT PRUNING TRENCH


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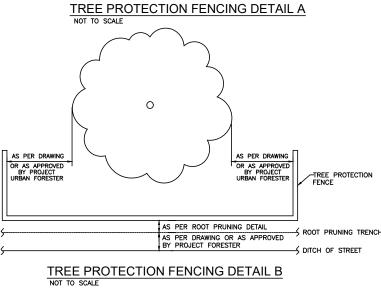
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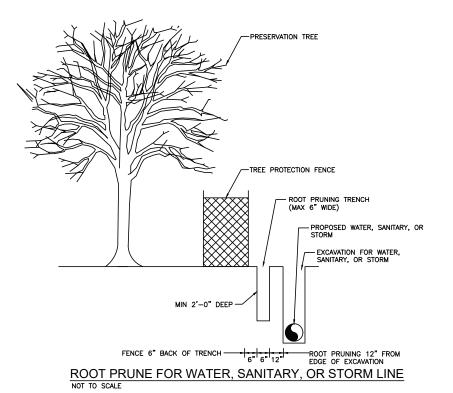
 IN AREAS WHERE INDIVIDUAL TREES HAVE NOT BEEN TIED IN BY SURVEY APPROXIMATE LOCATION IS INDICATED ON TPP. ACCURACY OF REPRESENTED LOCATION CAN'T, AND IS NOT GUARANTEED BY DESIGNER.

	TREE REMOVAL LIST					
Tree No.	Location	Description	Comments			
			Poor condition, 50% of canopy gone, Remove for street widening and			
3	16242 Seattle Street	15" Bradford Pear	stabilization back of curb			
			Topped, Scale insects, Black sooty mold, Poor condition, Remove for street			
10	16230 Seattle Street	9" Crepe Myrtle	widening and stabilization back of curb			
11	16245 Seattle Street	27" Water Oak	Good condition, Remove for street widening			
	16229 Seattle Street		Remove for street widening and stabilization back of curb			
	16213 Seattle Street	26" Live Oak	Good condition, Remove for street widening and manhole			
31	16213 Seattle Street	24" Live Oak	Good condition, Remove for street widening and BB inlet construction			
32	16209 Seattle Street	17" Live Oak	Good condition, Remove for street widening			
35	16209 Seattle Street	20" Live Oak	Good condition, Remove for street widening			
			Poor condition, 50% of canopy gone, Remove for street widening and			
39	16205 Seattle Street	6" Shumard Oak	stabilization back of curb			
42	16226 Seattle Street	15" Callery Pear	Remove for street widening and stabilization back of curb			
46	16218 Seattle Street	21" Live Oak	Good condition, Remove for street widening			
49	16218 Seattle Street	18" Live Oak	Good condition, Remove for street widening			
52	16214 Seattle Street	4" Crepe Myrtle	Remove for street widening and stabilization back of curb			
53	16214 Seattle Street	8" Crepe Myrtle	Remove for street widening and stabilization back of curb			
65	16202 Seattle Street	9" Crabapple	Remove for street widening and stabilization back of curb			
102	16106 Seattle Street	8" Crepe Myrtle	Remove for street widening and stabilization back of curb			
104	16102 Seattle Street	19" Crepe Myrtle	Remove for street widening and stabilization back of curb			
109	16022 Seattle Street	8" Crepe Myrtle	Topped, Remove for street widening and stabilization back of curb			
110	16022 Seattle Street	10" Crepe Myrtle	Topped, Remove for street widening and stabilization back of curb			
			Topped, Poor condition, Remove for street widening and stabilization back of			
114	Not available	22" Bradford Pear	curb			
			Topped, Poor condition, Remove for street widening and stabilization back of			
	Not available	22" Bradford Pear	curb			
126	16001 Seattle Street	9" Crepe Myrtle	Remove for street widening and stabilization back of curb			
			Topped, Poor condition, Remove for street widening and stabilization back of			
130	16001 Seattle Street	8" Crepe Myrtle	curb			





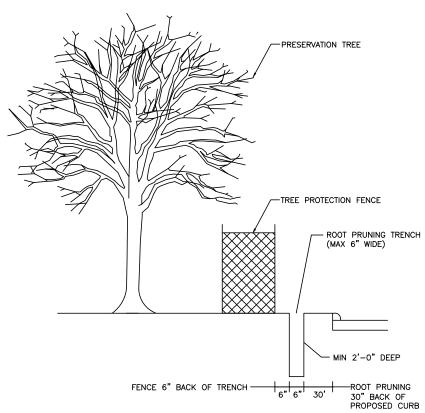

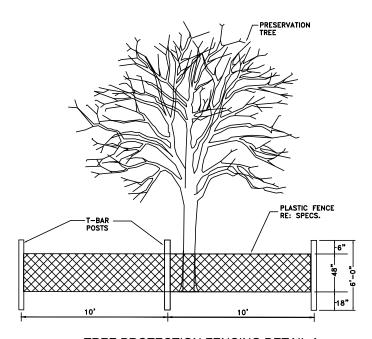




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SEATTLE STREET RECONSTRUCTION PROJECT

TREE PROTECTION PLAN SHEET 3 OF 4

NO.	DATE	R	REVISIONS	
_			T	
DRAWN BY: N.B.		N.B.	APPROVED BY: C.N.K.	
DES	SIGNED: (C.N.K.	DATE: 11-08-2021	
SCA	NLE:		SHEET 3/2 OF 52	2

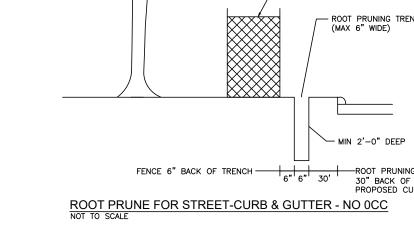

TREE AND PLANT PROTECTION

PART 1 - GENERAL

1.01 SECTION INCLUDES

- TREE AND PLANT PROTECTION
- MINIMUM OUALIFICATIONS OF ARBORIST

1.02 MEASUREMENT AND PAYMENT

- PAYMENT FOR TREE REMOVAL SHALL BE PAID PER EACH TREE REMOVED.
- PAYMENT FOR CLEARANCE PRUNING SHALL BE PAID FOR EACH TREE PRUNED
- PAYMENT FOR ROOT PRUNING TRENCH SHALL BE PAID ON A PER LINEAR FOOT INSTALLED BASIS.
- PAYMENT FOR TREE PROTECTION FENCE SHALL BE PAID ON A PER LINEAR FOOT INSTALLED BASIS
- PAYMENT FOR HAND DIG WATER SERVICE TAP & LEAD OR FITTINGS SHALL BE PAID PER EACH EXCAVATION PIT REQUIRED TO BE DUG BY HAND. ALL ADDITIONAL TREE PROTECTION TREATMENTS SHALL BE COMPLETED AT NO ADDITIONAL PAY AND ARE CONSIDERED INCIDENTAL.

- A. PRESERVE AND PROTECT EXISTING TREES AND PLANTS TO REMAIN FROM FOLIAGE, BRANCH, TRUNK, OR ROOT DAMAGE THAT COULD RESULT FROM CONSTRUCTION OPERATIONS.

- COMPACTION OF ROOT ZONE BY FOOT OR VEHICULAR TRAFFIC, OR MATERIAL STORAGE. TRUNK DAMAGE FROM EQUIPMENT OPERATIONS, MATERIAL STORAGE, OR FROM NAILING OR BOLTING.
- TRUNK AND BRANCH DAMAGE CAUSED BY ROPES OR GUY WIRES
- ROOT OR SOIL CONTAMINATION FROM SPILLED SOLVENTS, GASOLINE, PAINT, LIME SLURRY, AND OTHER NOXIOUS MATERIALS. BRANCH DAMAGE DUE TO IMPROPER PRUNING OR TRIMMING.
- DAMAGE FROM LACK OF WATER DUE TO:
- CUTTING OR ALTERING NATURAL WATER MIGRATION PATTERNS NEAR ROOT ZONES.
- b. FAILURE TO PROVIDE ADEQUATE WATERING.
 DAMAGE FROM ALTERATION OF SOIL PH CAUSED BY DEPOSITING LIME, CONCRETE, PLASTER, OR OTHER BASE MATERIALS NEAR ROOT ZONES
- CUTTING OF ROOTS LARGER THAN ONE INCH IN DIAMETER IN AREAS NOT CALLED OUT FOR ROOT PRUNING TRENCH.

1.04 DAMAGE ASSESSMENT

A. WHEN TREES OTHER THAN THOSE DESIGNATED FOR REMOVAL ARE DESTROYED OR DAMAGED AS A RESULT OF CONSTRUCTION OPERATIONS, REMOVE AND REPLACE WITH SAME SIZE, SPECIES, AND VARIETY UP TO AND INCLUDING 8 INCHES IN TRUNK DIAMETER. TREES LARGER THAN 8 INCHES IN DIAMETER SHALL BE REPLACED WITH AN 8-INCH DIAMETER TREE OF THE SAME SPECIES AND VARIETY AND TOTAL CONTRACT AMOUNT WILL BE REDUCED BY AN AMOUNT DETERMINED FROM THE FOLLOWING FORMULA: $0.7854 \times D^2 \times 125.00$ Where D is Diameter in inches of tree or shrub trunk measured 12 inches above grade for that portion of the tree which is greater than 8 inches in Diameter. REMOVAL MUST BE APPLIED FOR AND APPROVED BY THE CITY OF JERSEY VILLAGE PRIOR TO REMOVAL OF ANY TREE NOT SCHEDULED FOR REMOVAL IN THE TREE TREATMENT SCHEDULE.

PART 2 - PRODUCTS

- PRUNING PAINT: BLACK LATEX, WATER BASED PAINT, FREE OF ALL PETROLEUM PRODUCTS.
 FERTILIZER/ROOT STIMULANT: ROOT STIMULANT SHALL BE A ROOT STIMULANT THAT CONTAINS AT A MINIMUM THE FOLLOWING INGREDIENTS: ECTOMYCORRHIZAL FUNGI, VA MYCORRHIZAL (VAM) FUNGI, RHIZOSPHERE BACILLUS SPP., KELP MEAL, HUMIC ACID, AND SOLUBLE YUCCA. FERTILIZER SHALL BE DAVÉY ARBORGREEN.
- TREE PROTECTION FENCING: ORANGE, PLASTIC MESH FENCING, 4 FEET IN HEIGHT WITH 6 FEET HIGH "T" POSTS INSTALLED 10 FEET ON CENTERS AS PER DRAWINGS
- PLASTIC ROOT/SOIL PROTECTION: CLEAR POLYETHYLENE SHEETING, MINIMUM 6 MIL. THICKNESS.
- SANDY LOAM BACKFILL: A LOAM CONSISTING OF LESS THAN 7 PERCENT CLAY, LESS THAN 50 PERCENT SILT, AND BETWEEN 43 AND 50 PERCENT

3.01 PROTECTION OF EXISTING TREES AND SHRUBS

- SITE PREPARATION WORK AND/OR CONSTRUCTION WORK SHALL NOT BEGIN IN ANY AREA WHERE TREE PRESERVATION MEASURES HAVE NOT BEEN COMPLETED AND APPROVED BY CITY OF JERSEY VILLAGE.
- PROTECT EXPOSED ROOTS AND ROOT ZONE AREAS FROM CONTAMINATION FROM STABILIZATION MATERIALS AND CONCRETE USING PLASTIC ROOT/SOIL PROTECTION (POLYETHYLENE).
- COVER EXPOSED ROOTS WITHIN 4 HOURS TO REDUCE DAMAGE CAUSED BY DESICCATION. ROOTS MAY BE COVERED WITH SOIL, MULCH, POLYETHYLENE, OR WET BURLAP TO HELP PROTECT THEM FROM DRYING.
- DESIGNATE LIMITED AREAS AS CONCRETE WASHOUT AREAS. LOCATE CONCRETE WASHOUT AREAS AWAY FROM ROOT ZONES
- INSTALL ROOT PRUNING TRENCHING WHERE DESIGNATED IN TREE TREATMENT SCHEDULE AND SHOWN ON THE TREE PROTECTION DRAWINGS.
 TREES SCHEDULED FOR ROOT PRUNING ARE CALLED OUT SPECIFICALLY IN THE TREATMENT SCHEDULE. TRENCH SHALL BE LOCATED 2 FT. FROM THE EDGE OF PROPOSED WATERLINE OR SANITARY SEWER FOR TREES CALLED OUT FOR ROOT PRUNING FOR WATER OR FITTINGS, OR SANITARY SEWER IN THE TREATMENT SCHEDULE, 2 FT. FROM EDGE OF PROPOSED STORM SEWER PIPE FOR TREES CALLED OUT FOR ROOT PRÚNING FOR STORM IN THE TREATMENT SCHEDULE, 30" BACK OF PROPOSED CURB FOR TREES CALLED OUT FOR ROOT PRUNING FOR STREET WHERE ZERO CURB CUTBACK IS NOT ALSO CALLED OUT, AT BACK OF PROPOSED CURB WHERE ZERO CURB CUTBACK IS CALLED OUT IN SAME LOCATION AS ROOT PRUNING, AND AT EDGE OF SIDEWALK FOR TREES CALLED OUT FOR ROOT PRUNING FOR SIDEWALK. TRENCH LOCATIONS SHOWN ON TREE PRESERVATION PLAN ARE DRAWN TO SCALE AND SHOULD BE LOCATED IN FIELD AS DRAWN ON PLAN. EXACT LOCATIONS SHALL BE APPROVED IN THE FIELD BY THE ENGINEER AND/OR CITY OF JERSEY VILLAGE PRIOR TO INSTALLATION. TRENCHING DEPTH SHALL BE TO THE ANTICIPATED BOTTOM OF SIDEWALK AND BASE MATERIAL FOR SIDEWALK ROOT PRUNING; ROOTS LOWER THAN SIDEWALK SHALL NOT BE PRUNED. ALL ROOTS SHALL BE CUT BY TRENCHER, CHAINSAW, OR HANDSAW TO THE SPECIFIED DEPTH. ROOTS SHALL BE CUT CLEANLY, AND NOT RIPPED, TORN, OR CHOPPED. TRENCH SHALL BE BACKFILLED AND COMPACTED IMMEDIATELY AFTER TRENCHING. TRENCH SHALL BE INSTALLED PRIOR TO ANY CLEARING AND GRUBBING EXCAVATION FOR BASE MATERIAL, OR ANY OTHER SITE WORK
- INSTALL TREE PROTECTION FENCING AROUND EACH TREE TO BE PRESERVED AS INDICATED IN THE TREE TREATMENT SCHEDULE AND ON THE TREE
- EACH TREE TO BE PRESERVED SHALL BE PROTECTED WITH A TREE PROTECTION FENCE. THE FENCING SHALL BE CONTINUOUS BETWEEN POSTS, SHALL BE PULLED TAUT PRIOR TO SECURING TO POSTS, AND SHALL BE FIRMLY ATTACHED TO THE POSTS WITH A MINIMUM OF 4 WIRE OR
- ALL TREE PROTECTION FENCING SHALL BE INSTALLED PRIOR TO SITE WORK OR CONSTRUCTION ACTIVITY. THE FENCE SHALL BE PLACED IN A CONTINUOUS ALIGNMENT AS SHOWN ON THE TREE PROTECTION PLAN. FENCES SHOWN ON TREE PROTECTION PLAN ARE DRAWN TO SCALE AND SHALL BE INSTALLED AS DRAWN, IN THE FIELD. IN GENERAL FENCES SHALL BE PLACED 30" BACK OF EXISTING CURB OR EDGE OF PAVEMENT WHERE ROOT PRUNING OR ZERO CURB CUTBACK IS NOT SPECIFIED, AND 6" BACK OF ROOT PRUNING TRENCH WHERE ROOT PRUNING IS SPECIFIED AND 12" BACK OF CURB WHERE ZERO CURB CUTBACK IS SPECIFIED. EXACT LOCATIONS SHALL BE APPROVED BY THE CITY OF JERSEY VILLAGE AND/OR ENGINEER IN THE FIELD. THE FENCES SHALL BE PLACED TO PROTECT ROOTS, TRUNKS, AND FOLIAGE. THE CONTRACTOR SHALL NOT REMOVE OR RELOCATE TREE PROTECTION FENCING AND SHALL NOT OPERATE WITHIN THE LIMITS SHOWN WITHOUT DIRECT APPROVAL OF THE CITY OF JERSEY VILLAGE. NO BORE PITS, PEEP HOLES, SERVICE TAPS, OR ANY EXCAVATION SHOULD OCCUR IN THE AREA OF THE TREE PROTECTION FENCING FOR TREES CALLED OUT WITH "BORE" IN THE TREE TREATMENT SCHEDULE. THE "BORE" LIMITS SHALL BE THE SAME AS THE LIMITS OF THE TREE PROTECTION FENCING.
- STORAGE OF EQUIPMENT OR MATERIALS WILL NOT BE ALLOWED INSIDE A FENCE. ENTRYWAYS AND ACCESS INTO A PROTECTED AREA SHALL NOT BE PROVIDED UNLESS APPROVED BY THE CITY OF JERSEY VILLAGE.
- DAMAGE TO TREE FENCES OCCURRING DURING THE PROGRESS OF THE WORK SHALL BE REPAIRED IMMEDIATELY AT NO ADDITIONAL COST TO OWNER. WORKMEN SHALL BE CLEARLY INSTRUCTED TO EXERCISE CAUTION IN PERFORMANCE OF WORK NEAR TREES BEING PRESERVED.
- TREE PROTECTION FENCING SHALL BE REMOVED BY CONTRACTOR, AT NO ADDITIONAL COSTS, UPON COMPLETION OF ALL CONSTRUCTION ACTIVITY IN EACH WORK ZONE AREA. TREE PROTECTION FENCING MATERIALS USED IN THE FIRST TWO WORK ZONE AREAS SHALL BE REMOVED AND UTILIZED IN SUBSEQUENT WORK ZONE AREAS. MATERIALS AND LABOR SHALL BE PAID FOR EACH LINEAR FOOT OF FENCING INSTALLED IN FIRST TWO WORK AREAS. ALL FENCING INSTALLED IN SUBSEQUENT WORK ZONE AREAS SHALL BE PAID FOR LABOR ONLY.

- G. BORING/AUGURING OF WATER LINES OR SANITARY SEWER LINES
- WATER LINE OR SANITARY SEWER LINE SHALL BE BORED/AUGURED/HORIZONTALLY DRILLED UNDER CRITICAL ROOT ZONE AREAS OF TREES DESIGNATED WITH AUGER OR BORE IN THE TREE TREATMENT SCHEDULE. THE ENTIRE AREA PROTECTED WITH TREE PROTECTION FENCING SHALL BE BORED. NO BORE PITS, COME THROUGH HOLES, PEEP HOLES, PUSH PITS, OR LONG OR SHORT SIDE SERVICE TAPS SHALL BE ALLOWED IN THE AREAS PROTECTED BY TREE PROTECTION FENCING. THE TREE PROTECTION PLAN TAKES INTO CONSIDERATION THE LIMITS OF AUGURING EQUIPMENT, THERE SHOULD BE ROOM FOR ADEQUATELY SPACED BORE PITS, PEEP HOLES, COME THROUGH HOLES, AND PUSH PITS ANY CHANGES TO THE LOCATION OF THE TREE PROTECTION FENCING SHALL BE AUTHORIZED BY THE CITY OF JERSEY VILLAGE AND/OR
- H. HAND DIGGING OF SERVICE TAPS AND LEADS, FIRE HYDRANTS AND FITTINGS
 - TREES CALLED OUT FOR HAND DIG SHORT SIDE SERVICE TAP ARE LOCATED IN VERY CLOSE PROXIMITY TO EXISTING SHORT SIDE WATER METERS. EXCAVATING THE SERVICE TAP WITH MACHINERY WOULD SIGNIFICANTLY IMPACT THE TREE. THESE SHORT SIDE SERVICE TAPS SHALL BE EXCAVATED WITH MANUAL LABOR TO EXPOSE ANY ROOTS 1" IN DIAMETER AND LARGER. THE FIRST 24" OF EXCAVATION SHALL BE COMPLETED MANUALLY TO EXPOSE THE ROOTS. ANY ROOT 1" IN DIAMETER AND LARGER SHALL REMAIN UNDAMAGED, THE ROOTS SHALL NOT BE CUT, NOR SHALL THE BARK AND CAMBIUM LAYER BE SCRAPED OR DAMAGED. ONCE THE ROOTS ARE EXPOSED, IF THERE IS ADEQUATE ROOM TO UTILIZE A MINI-EXCAVATOR WITHOUT DAMAGING THE ROOTS, THE MINI-EXCAVATOR CAN BE UTILIZED TO COMPLETE THE EXCAVATION DOWN TO THE WATER LINE. 1" PLYWOOD SHALL BE PLACED ON GRADE TO PROVIDE ROOT PROTECTION IN THE AREA OF ACCESS OF THE MINI-EXCAVATOR. IF ROOTS I" DIAMETER OR LARGER ARE CUT OR DAMAGED, RESPONSIBLE PARTY WILL BE SUBJECT TO A CITATION UNDER THE TREE ORDINANCE, AND MAY ALSO BE REQUIRED TO INCUR THE COST OF TREE REMOVAL AND REPLACEMENT OF DAMAGED TREE ON AN INCH FOR INCH BASIS, IF REQUIRED BY CITY OF JERSEY VILLAGE.
 - TREES CALLED OUT FOR HAND DIG SHORT SIDE OR LONG SIDE SERVICE LEAD ARE LOCATED IN VERY CLOSE PROXIMITY TO EXISTING WATER METERS. EXCAVATING THE SERVICE LEAD WITH MACHINERY WOULD SIGNIFICANTLY IMPACT THE TREE. SHORT SIDE LEADS SHALL BE EXCAVATED WITH MANUAL LABOR TO EXPOSE ANY ROOTS 1" IN DIAMETER AND LARGER FROM THE SERVICE TAP TO THE METER. COME OUT HOLES AND EXCAVATION REQUIRED FOR LONG SIDE SERVICE LEADS SHALL BE EXCAVATED WITH MANUAL LABOR TO EXPOSE ROOTS I" IN DIAMETER AND LARGER, FROM THE COME OUT HOLE TO THE METER. IN EACH CASE, ALL ROOTS 1" IN DIAMETER AND LARGER SHALL REMAIN UNDAMAGED, THE ROOTS SHALL NOT BE CUT, NOR SHALL THE BARK AND CAMBIUM LAYER BE SCRAPED OR DAMAGED. IF ROOTS 1" DIAMETER OR LARGER ARE CUT OR DAMAGED, RESPONSIBLE PARTY WILL BE SUBJECT TO A CITATION UNDER THE TREE ORDINANCE, AND MAY ALSO BE REQUIRED TO INCUR THE COST OF TREE REMOVAL AND REPLACEMENT OF DAMAGED TREE ON AN INCH BY INCH BASIS, IF REQUIRED BY CITY OF JERSEY VILLAGE
 - TREES CALLED OUT FOR HAND DIG FIRE HYDRANT, TEE, OR FITTING ARE LOCATED IN VERY CLOSE PROXIMITY TO PROPOSED FITTING EXCAVATING THE FITTING WITH MACHINERY WOULD SIGNIFICANTLY IMPACT THE TREE AND BE IN VIOLATION OF THE TREE ORDINANCE. EXCAVATION FOR FIRE HYDRANT OR FITTING SHALL BE COMPLETED WITH MANUAL LABOR TO EXPOSE ANY ROOTS 1" IN DIAMETER AND LARGER. IN EACH CASE, ALL ROOTS 1" IN DIAMETER AND LARGER SHALL REMAIN UNDAMAGED, THE ROOTS SHALL NOT BE CUT, NOR SHALL THE BARK AND CAMBIUM LAYER BE SCRAPED OR DAMAGED. IF ROOTS 1" DIAMETER OR LARGER ARE CUT OR DAMAGED, RESPONSIBLE PARTY WILL BE SUBJECT TO A CITATION UNDER THE TREE ORDINANCE, AND MAY ALSO BE REQUIRED TO INCUR THE COST OF TREE REMOVAL AND REPLACEMENT OF DAMAGED TREE ON AN INCH BY INCH BASIS, IF REQUIRED BY CITY OF JERSEY VILLAGE.

 LONG SIDE SERVICE TAPS SHALL NOT BE LOCATED IN AN AREA SPECIFIED TO BE BORED IN THE TREE TREATMENT SCHEDULE. SHOULD IT BE
 - ABSOLUTELY NECESSARY TO LOCATE A LONG SIDE SERVICE TAP IN AN AREA SPECIFIED TO BE BORED, THE EXCAVATION SHALL BE COMPLETED AS SPECIFIED IN PARAGRAPH 1 OF THIS SECTION-HAND DIGGING SHORT SIDE SERVICE TAPS.
 - ALL WATER METERS AND SANITARY SERVICE LEADS CALLED OUT ON P&P DRAWINGS AND VISIBLE IN THE FIELD HAVE BEEN ADDRESSED IN THE TREE PROTECTION PLAN. SHOULD ANY ADDITIONAL METERS OR LEADS BE FOUND DURING CONSTRUCTION, OR ANY NEW METERS OR LEADS INSTALLED BENEATH THE CANOPY OF ANY TREE, OR IN THE AREAS FENCED FOR TREE PROTECTION, THE EXCAVATION SHALL BE COMPLETED AS SPECIFIED IN PARAGRAPH 1 AND/OR 2 OF THIS SECTION AND PAID FOR AT THE UNIT COSTS FOR EACH INCLUDED IN THE CONTRACT.

- TREES SHALL BE PRUNED IN ACCORDANCE WITH THE AMERICAN NATIONAL STANDARD FOR TREE PRUNING, ANSI A300 (PART 1) 2001 PRUNING REVISION OF ANSI A300-1995 TREE, SHRUB AND OTHER WOODY PLANT MAINTENANCE STANDARD PRACTICES. PRUNING SHALL BE COMPLETED BY PROFESSIONAL ARBORISTS WHO HAS RECEIVED TRAINING IN PROPER PRUNING TECHNIQUES.
- CLEARANCE PRUNE DESIGNATED TREES IN TREE PROTECTION PLAN FOR PUBLIC SIDEWALKS AND CONSTRUCTION AREAS. PROVIDE 8 FEET OF VERTICAL CLEARANCE OVER PROPOSED SIDEWALKS. PRUNING TO BE INSTALLED PRIOR TO ANY CONSTRUCTION ACTIVITY. CONTRACTOR SHALL NOTIFY PROPERTY OWNER PRIOR TO TRIMMING OR PRUNING ANY TREES WITH TRUNKS LOCATED ON PRIVATE PROPERTY.
- ALL CUTS SHOULD BE MADE SUFFICIENTLY CLOSE TO THE PARENT LIMB OR TRUNK WITHOUT CUTTING INTO THE BRANCH COLLAR OR LEAVING A PROTRUDING STUB, SO THAT CLOSURE CAN READILY START UNDER NORMAL CONDITIONS. ALL LATERAL CUTS SHALL BE MADE BACK TO A LATERAL THAT IS AT LEAST 1/3 THE DIAMETER OF THE PARENT LIMB. CLEAN CUTS SHALL BE MADE AT ALL TIMES. TREES SHALL BE PRUNED IN A MANNER THAT WILL NOT DESTROY OR ALTER THE NATURAL SHAPE AND CHARACTER OF THE TREE. APPLY
- BLACK LATEX PAINT TO ALL FRESH WOUNDS ON OAK (QUERCUS) SPECIES IMMEDIATELY AFTER EACH CUT IS MADE

- TREES SCHEDULED FOR REMOVAL SHALL BE SAWED DOWN AND DEBRIS HAULED FROM THE SITE THE SAME DAY. THE STUMP SHALL BE GROUND TO 6" BELOW GRADE AND EXCESS GRINDINGS SHALL BE HAULED FROM THE SITE THE SAME DAY, SO THAT A PILE OF GRINDINGS IS NOT LEFT WHERE THE STUMP WAS GROUND. ENOUGH GRINDINGS SHOULD BE LEFT SO THAT AN OPEN HOLE DOES NOT REMAIN.
- ONLY THOSE TREES CALLED OUT FOR REMOVAL IN THE TREE TREATMENT SCHEDULE SHALL BE REMOVED, OR OTHERWISE DAMAGED. SHOULD IT BE DETERMINED THAT ANY ADDITIONAL TREES MUST BE REMOVED, REQUEST MUST BE APPLIED FOR AND APPROVED FROM THE CITY OF JERSEY VILLAGE PRIOR TO REMOVAL.
- K. REGULARLY WATER TREES WHICH HAVE RECEIVED ROOT DAMAGE, TO ELIMINATE ADDITIONAL STRESS CAUSED BY LACK OF MOISTURE. WATER DURING PERIODS WITHOUT ADEQUATE RAINFALL. FOR EXAMPLE, SHOULD 1.0" OF RAIN NOT BE RECEIVED WITHIN A WEEK PERIOD, THE TREES SHOULD BE THOROUGHLY WATERED. MARCH THROUGH SEPTEMBER, WATER ONCE EVERY TWO WEEKS. OCTOBER THROUGH FEBRUARY, WATER EVERY THREE WEEKS. WATER THOROUGHLY TO SATURATE THE ENTIRE ROOT ZONE AREA.
- L. CHEMICALLY TREAT TREE TRUNKS WITH EVIDENCE OF BORER ACTIVITY WITH THE APPROPRIATE APPROVED INSECTICIDE MIXED AND APPLIED PER THE MANUFACTURER'S PRODUCT APPLICATION RECOMMENDATIONS. TREES SHALL BE SPRAYED WITHIN 24 HOURS AFTER OBSERVANCE OF BORER

- MAINTAIN EXISTING GRADE WITHIN THE DRIPLINE OF TREES, UNLESS OTHERWISE INDICATED.
 WHERE EXISTING GRADE AROUND TREES IS ABOVE NEW FINISH GRADE, UNDER SUPERVISION OF PROJECT ARBORIST AND CITY OF JERSEY VILLAGE, CAREFULLY HAND EXCAVATE WITHIN THE DRIPLINE TO MAKE TRANSITION TO NEW FINISH GRADE.
- WHERE EXISTING GRADE IS BELOW NEW FINISH GRADE, PLACE SANDY LOAM SOIL IN A SINGLE LAYER TO MAKE THE TRANSITION TO NEW GRADE. DO NOT COMPACT; HAND GRADE TO REQUIRED ELEVATION.

 N. DEMOLITION, FORMING AND POURING SIDEWALKS (SIDEWALK ON GRADE)
- DEMOLITION OF EXISTING SIDEWALKS, LOCATED IN CRITICAL ROOT ZONE ARE OF A TREE, SHALL BE COMPLETED WITHOUT DISTURBING, CUTTING, OR OTHERWISE DAMAGING TREE ROOTS AND SOIL LOCATED BENEATH THEM.
- THE NEW SIDEWALK SHALL BE FORMED AT OR ABOVE THE ELEVATION OF ROOTS 1" DIAMETER AND LARGER, WITHOUT DISTURBING, CUTTING OR OTHERWISE DAMAGING TREE ROOTS. BASE MATERIAL COMPACTION SHALL NOT BE INSTALLED IF TREE ROOTS 1" DIAMETER OR LARGER ARE ENCOUNTERED. EVERY EFFORT HAS BEEN MADE TO ADDRESS TREE ROOT AND SIDEWALK ELEVATION ISSUES WITH INFORMATION AVAILABLE IN THE FIELD AND ON PLAN AND PROFILE SHEETS. THE ELEVATION OF EVERY TREE ROOT WAS NOT AVAILABLE, IF TREE ROOTS ARE FOUND TO BE IN CONFLICT WITH PROPOSED SIDEWALK, PROJECT ENGINEER, ARBORIST AND CITY OF JERSEY VILLAGE SHALL BE CONSULTED AS TO HOW TO INSTALL SIDEWALKS WITH MINIMAL IMPACTS TO ADJACENT TREES.
- O. DEMOLITION, FORMING AND POURING OF DRIVE WAY APPROACHES
 - DEMOLITION OF EXISTING DRIVEWAY APPROACHES LOCATED BENEATH THE DRIPLINE OF ANY TREE SHALL BE COMPLETED WITHOUT DISTURBING, CUTTING, OR OTHERWISE DAMAGING TREE ROOTS AND SOIL LOCATED BENEATH THEM.
 - THE NEW APPROACH SHALL BE FORMED AT OR ABOVE THE ELEVATION OF THE EXISTING APPROACH WHERE TREE ROOTS 1" DIAMETER OR LARGER ARE PRESENT, WITHOUT DISTURBING, CUTTING OR OTHERWISE DAMAGING TREE ROOTS. MAXIMUM DRIVE SLOPES MAY BE NEEDED AT BOTTOM OF APRON TO ALLOW FORMING OF DRIVE OVER TREE ROOTS AT TOP OF DRIVE. AS WITH SIDEWALKS, THE ELEVATION OF EVERY TREE ROOT WAS NOT AVAILABLE IN DESIGN. IF TREE ROOTS ARE FOUND TO BE IN CONFLICT WITH PROPOSED APPROACH, PROJECT ENGINEER, ARBORIST AND CITY OF JERSEY VILLAGE SHALL BE CONSULTED AS TO HOW TO INSTALL DRIVEWAY WITH MINIMAL IMPACTS TO ADJACENT
- P ARBORIST QUALIFICATIONS
 - ARBORIST EMPLOY QUALIFIED ARBORIST ACCEPTABLE TO CITY TO COMPLETE ALL TREE TREATMENTS. ARBORIST SHALL BE NORMALLY ENGAGED IN THE FIELD AND HAVE A MINIMUM OF 5 YEARS' EXPERIENCE. QUALIFICATIONS OF THE SELECTED ARBORIST SHALL BE SUBMITTED FOR REVIEW AND APPROVAL BY THE PROJECT ENGINEER AND CITY OF JERSEY VILLAGE.



16327 LAKEVIEW DR. JERSEY VILLAGE, TX 77040

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C.IV. NO	rential
Urban Forestry, Inc.	

210 Stone Bush Ct. . Katv. Texas 7749.

281-391-0022 ckoehl@koehlurbanforestrv.com APPROVED Crois N. Koell 11-08-2021

SEATTLE STREET RECONSTRUCTION PROJECT

TREE PROTECTION PLAN SHEET 4 OF 4

REVISIONS

DRA	DRAWN BY: N.B.		APPROVED BY: C.N.K.				
DES	DESIGNED: C.N.K.		DATE:	11-08-	2021		
SCA	LE:		SHEET	332	OF	52	

TRAFFIC CONTROL PLAN NARRATIVE:

CONSTRUCT THE WORK IN PHASES DURING THE CONSTRUCTION PERIOD, COORDINATE CONSTRUCTION SCHEDULE AND OPERATIONS WITH THE CITY:


1. PHASE 1: CONSTRUCT THE NORTH HALF OF SEATTLE STREET FROM THE CARLSBAD STREET INTERSECTION TO THE WEST END. CONSTRUCTION ACTIVITIES INCLUDE BUT ARE NOT LIMITED TO STORM DRAINAGE FACILITIES, WATER DISTRIBUTION FACILITIES, STREETLIGHT CONDUIT, PAVEMENT, DRIVEWAYS, SIDEWALKS, AND SITE RESTORATION. CONSTRUCT DRAINAGE FACILITIES FROM THE DOWNSTREAM TIE-IN AT CARLSBAD STREET TO THE MANHOLES AND INLETS. PROVIDE POSITIVE DRAINAGE THROUGHOUT.


CONSTRUCT THE NORTH HALF OF SEATTLE STREET FROM THE SENATE AVENUE INTERSECTION WEST TO CARLSBAD STREET. CONSTRUCTION ACTIVITIES INCLUDE BUT ARE NOT LIMITED TO STORM DRAINAGE FACILITIES, WATER DISTRIBUTION FACILITIES, STREETLIGHT CONDUIT, PAVEMENT, DRIVEWAYS, SIDEWALKS, AND SITE RESTORATION. CONSTRUCT DRAINAGE FACILITIES FROM THE DOWNSTREAM TIE-IN AT SENATE AVENUE TO THE UPSTREAM MANHOLES AND INLETS. PROVIDE POSITIVE DRAINAGE THROUGHOUT.

2. PHASE 2: CONSTRUCT THE SOUTH HALF OF SEATTLE STREET FROM THE CARLSBAD STREET INTERSECTION TO THE WEST END. CONSTRUCTION ACTIVITIES INCLUDE BUT ARE NOT LIMITED TO STORM DRAINAGE FACILITIES, WATER DISTRIBUTION FACILITIES, STREETLIGHT CONDUIT, SANITARY SEWER FACILITIES, PAVEMENT, DRIVEWAYS, SIDEWALKS, AND SITE RESTORATION.

CONSTRUCT THE SOUTH HALF OF SEATTLE STREET FROM THE SENATE AVENUE INTERSECTION WEST TO CARLSBAD STREET. CONSTRUCTION ACTIVITIES INCLUDE BUT ARE NOT LIMITED TO STORM DRAINAGE FACILITIES, WATER DISTRIBUTION FACILITIES, STREETLIGHT CONDUIT, SANITARY SEWER FACILITIES, PAVEMENT, DRIVEWAYS, SIDEWALKS, AND SITE RESTORATION.

3. ACTIVE WORK ZONES UTILIZING ONE WAY TRAFFIC SHALL NOT EXCEED 800 FEET IN LENGTH UNLESS AUTHORIZED BY THE CITY.

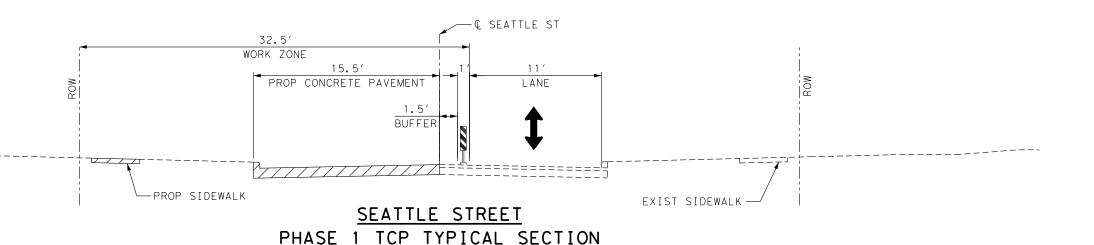

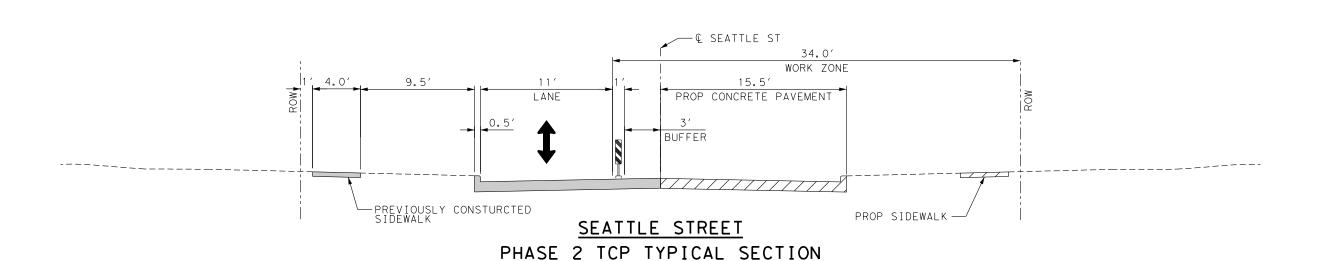





SEATTLE STREET
RECONSTRUCTION PROJECT

TRAFFIC CONTROL
TYPICAL SECTIONS

NO.	DATE		REVISIONS					BY
DRA	WN BY:	TJR		APPRO	VED BY	: CAH		
DES	IGNED: [)PS		DATE:	3/31/	2022		
SCA	LE:			SHEET:	34	OF	53	

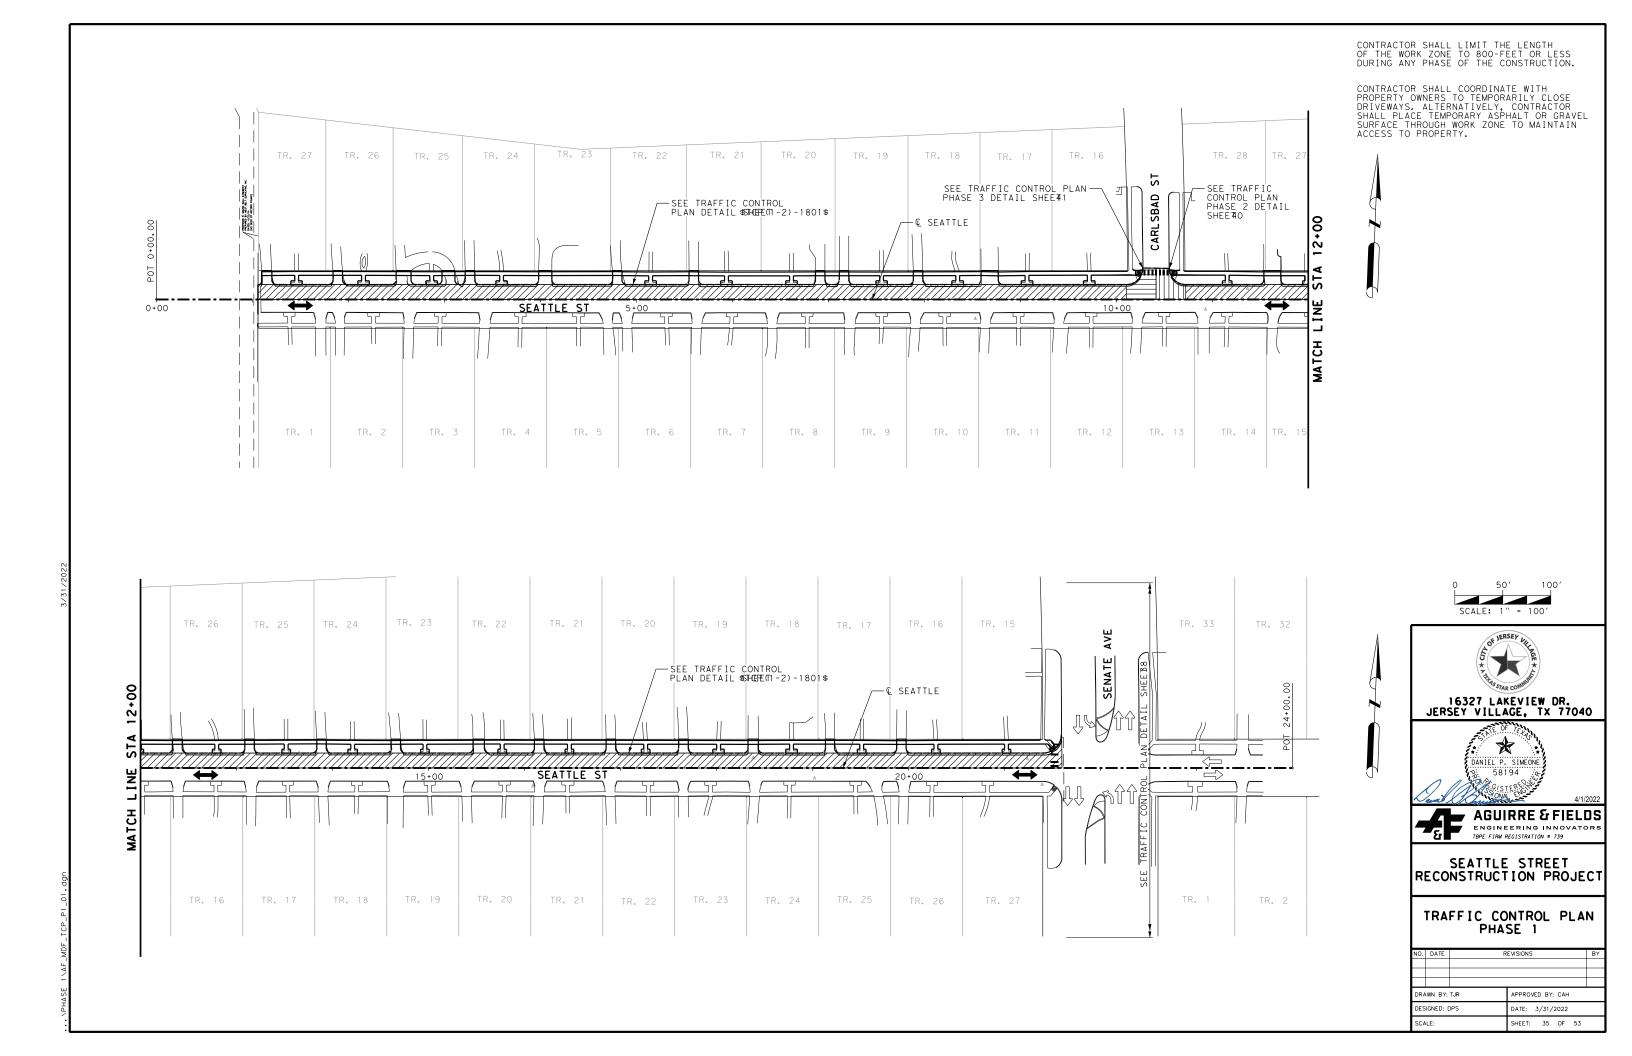

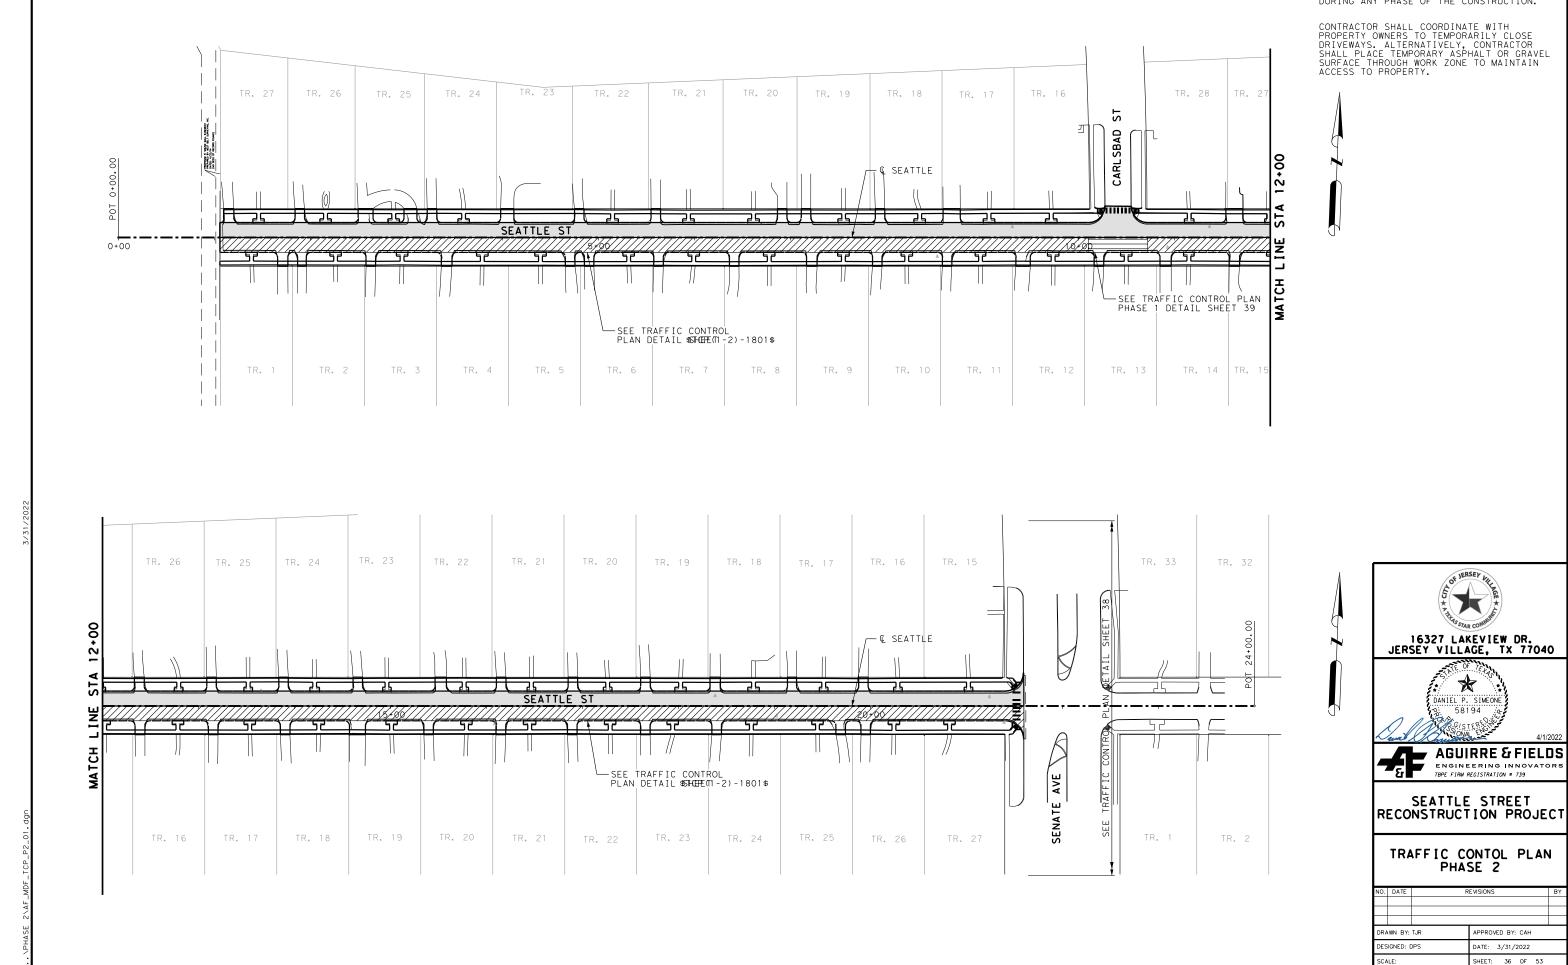

CONTRACTOR SHALL LIMIT THE LENGTH OF THE WORK ZONE TO 800-FEET OR LESS DURING ANY PHASE OF THE CONSTRUCTION.

0.	DATE	R	EVISIONS BY		
RAWN BY: TJR			APPROVED BY: CAH		
ES	IGNED: [)PS	DATE: 3/31/2022		
C.	LE:		SHEET: 36 OF 53		

2. All signs and traffic control devices shall conform the latest version of the TMUTCD

3. No lanes shall be closed during the hours of 7:00 AM to 9:00 AM and 4:00 PM to 6:00 PM Monday thru Friday without approval of the City Traffic

No work shall be performed in residential areas from 7:00 PM to 7:00 AM.

5 Contractor shall maintain approved number of through lanes of traffic in each direction during construction working hours. Traffic control plans shall include one-way and/or detour plans. Contractor shall maintain ADA compliant pedestrian access to bus stops and adequate bus access to all the

6. Contractor shall maintain traffic lanes and detours according to traffic control plans during working hours.

7. Contractor shall cover open pavement excavations for minor utility work with anchored steel plate during non-working hours, and open lanes for

8. If the Contractor chooses to use a different method of "Traffic Control Plans" during the construction than what is outlined in the contract crawings, the Contractor shall be responsible for prepare and submit an alternate set of traffic control plans to the City of Houston Project Manager for approval ten working days prior to implementation. These plans shall be drawn to scale and reproducible in mylars and shall be sealed by a Licensed Engineer in the State of Texas. Transportation & Drainage Operations representative approval is required to accept the proposed

9. Contractor shall secure lane/sidewalk/bicycle facility closure permits from Transportation & Drainage Operations (Mobility Permit Section at http://www.gims.houstontx.gov/portal/WS/MainPortal.aspx) before implementing the traffic control plans, construction sequencing, and construction schedule with the application.

10. Contractor shall have approved traffic control plan and permit at the job site for inspection at all times.

11. During pavement surface restoration projects; the Contractor shall not open closed lanes until the pavement surface has cured enough to allow vehicular traffic according to City of Houston Standard Specifications.

12. The Contractor is responsible for scheduling and coordinating all construction activities with stake holders in the vicinity including emergency response agencies such as Houston Police Department, Houston Fire Department, and Metropolitan Transit Authority.

13. Contractor shall be responsible for issuing all work directives to all sub-contractors, utility companies, and all other entities performing construction

14. Nothing in these notes or plans shall relieve the Contractor of the responsibility for job site conditions during the course of construction of the project; including safety of all modes of transportation, persons, and property, and that this requirement shall apply continuously and not be limited

15. The Transportation & Drainage Operations (Mobility Permits Group) per the direction of the City Traffic Engineer have the right to demand the installation of additional traffic control devices or modifications of these plans and notes, as deemed necessary to promote the safe and orderly flow of traffic, including pedestrians and bicycles, through the construction work zone. The Contractor shall comply with these additional requests or

16. All existing traffic control signs and pavement markings shall be maintained in visible locations during construction unless prior written approval is obtained from City of Houston Project Manager. The Contractor shall restore or replace (at the discretion of the City Traffic Engineer) any pavement marking or signing damage during construction operations, including Raised Pavement Markers (RPMs)

17. When entering or leaving roadways carrying public traffic, the Contractor's equipment whether empty or loaded shall in all cases yield to public traffic with assistance of Contractor provided certified flagger/peace officer.

18. Access to driveways adjacent to the construction work zone shall be maintained at all times as much as possible. Additional cones delineators may be required to delineate the driveway access route through the construction zone. A minimum of a travel lane shall be maintained across the driveways, unless prior written approval is obtained from City of Houston Project Manager.

19. Spillage resulting from hauling operations along or across any public traveled way shall be removed immediately by the Contractor.

20. The Contractor shall submit an application for temporary parking restrictions if there are parking meters located at the proposed lane closures from Parking Management Division (832-393-8690) at least ten business days before implementation of lane closures. In addition, temporary no parking signs shall be posted 24 hours prior to commencement of work.

21. Additional off duty officers/flaggers may be requested to direct traffic when lanes are blocked at the discretion of the City Project Manager even if they are not specifically identified on the project plans.

22. The Contractor shall replace within 72 hours, all traffic signal loop detectors damaged during construction.

23. In general, a solar powered flashing arrow board shall be required on all major thoroughfare lanes closures. Exceptions to flashing arrow boards and/or implementation on residential lane closures shall be approved by City Traffic Engineer.

24. Approved traffic control plan shall be in place before starting any excavation.

SPACING FOR CHANNELIZING DEVICES

- A. Plastic drums on merging taper @ 30' c c with chevron sign @ 60' c c and warning lights for overnight closure.
- B. Plastic drums on downstream taper @ 30' c c (return taper and barricade are optional and divided roadway section)

Plastic drums on radii @ 35' c -c.

Plastic drums on tangent @ 35' c - c with vertical panel at 70' c - c and approved warning

light @ 70' c - c (for overnight closure).

E. Plastic drums in front of construction zone @ 20' c - c with vertical panel at 40' c - c and

approved warning light @ 40' c - c (for overnight closure).

Concrete Traffic Barrier (CTB) or Low Profile Concrete Traffic Barrier (LPCTB) with approved reflectors @ 10' c - c if pavement drop is greater than 1 foot.

Plastic drums w/Guard rail mounted

H. Self- Righting vertical panel spacing.


4 lanes to 2 lanes undivided roadway section @ 20' c - c. 4 lanes divided roadway to one side two way roadway @ 20' c - c.

Left lane and right lane storage bays @ 15' c - c.


Spacing shown on traffic control shall supersede the above spacing.

Spacing may be adjusted to provide driveways, intersections and /or median openings.

CHANNELIZATION AND BARRICADES

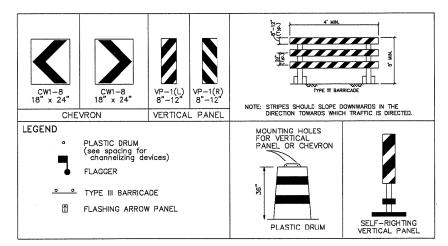

TYPIC	CAL SIGN SPACIN	G OF CH				IED .
			Desirable Length "L"		Suggeste Spacing (d Maximum Of Device
Posted Speed (mph)	Sign Spacing "X"	10' Offset	11' Offset	12' Offset	On a Taper	On a Tangent
30	120'	150'	165'	180'	30'	60' - 75'
35	160'	205'	225'	245'	35'	70' - 90'
40	240'	265'	295'	320'	40'	80' - 100'
45	320'	450'	495'	540'	45'	90' - 110'
50	400'	500'	550'	600'	50'	100' - 125'
55	500'	550'	605'	660'	55'	110' - 140'

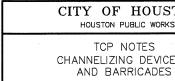



EFF DATE: JUL-01-2018

CITY OF HOUSTON

TCP NOTES CHANNELIZING DEVICES AND BARRICADES

(NOT TO SCALE)

und Haddade DIRECTOR OF HOUSTON PUBLIC WORKS

DWG NO: 01512-01

RM050425 - BRASS DISK STAMPED "050425" LOCATED AT THE NORTHEAST CORNER OF THE BRIDGE ON RIO GRANDE OVER E127-00-00 ±60 SOUTH OF VILLAGE DRIVE IN KEY MAP 409L IN THE WHITE OAK BAYOU WATERSHED. ELEVATION = 104.75' (NAVD 88, 2001 ADJ.)

TEMPORARY BENCHMARKS:

REFERENCE BENCHMARK:

TBM "A" - BOX CUT ON "BB" INLET LOCATED AT THE NORTHWEST CORNER OF SEATTLE STREE AND SENATE AVENUE. ELEVATION = 103.44'

TBM "B" - BOX CUT ON "BB" INLET LOCATED AT THE SOUTHWEST CORNER OF SEATTLE STREET AND CARLSBAD STREET. ELEVATION = 103.68'

TBM "C" - BOX CUT ON THE END OF THE CONCRETE SIDEWALK AT THE SOUND WALL LOCATED ON THE SOUTH SIDE OF SEATTLE STREET. ELEVATION = 106.16



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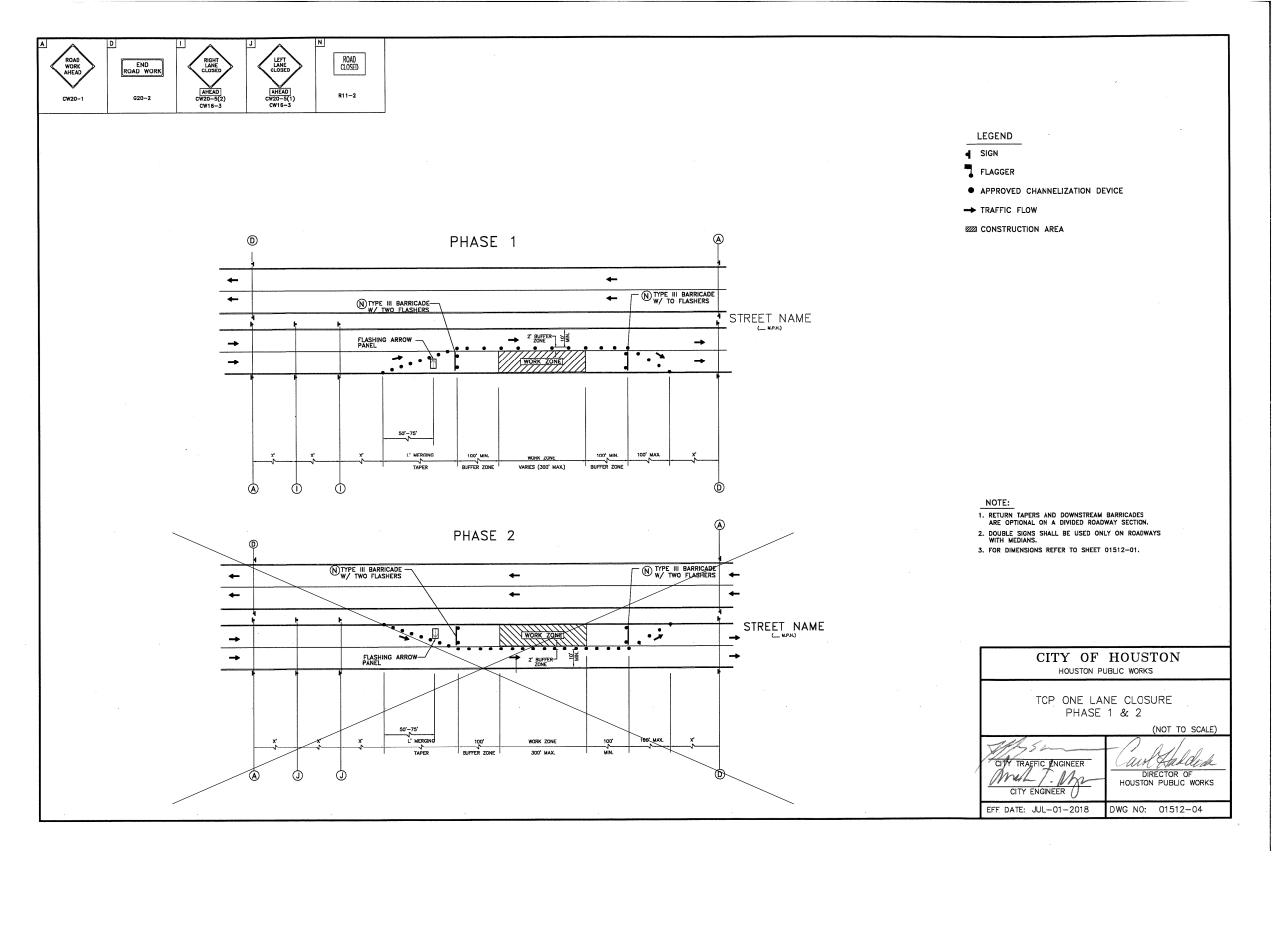


AGUIRRE & FIELDS ENGINEERING INNOVATOR TRPF FIRM REGISTRATION # 739

SEATTLE STREET RECONSTRUCTION PROJECT

> TRAFFIC CONTROL DETAILS

RAWN BY: TJR APPROVED BY: CAH ESIGNED: DPS DATE: 3/31/2022 SHEET: 37 OF 53



RM050425 - BRASS DISK STAMPED "050425" LOCATED AT THE NORTHEAST CORNER OF THE BRIDGE ON RIO GRANDE OVER E127-00-00 ±60' SOUTH OF VILLAGE DRIVE IN KEY MAP 409L IN THE WHITE OAK BAYOU WATERSHED. ELEVATION = 104.75' (NAVD 88, 2001 ADJ.)

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TBM "C" - BOX CUT ON THE END OF THE CONCRETE SIDEWALK AT THE SOUND WALL LOCATED ON THE SOUTH SIDE OF SEATTLE STREET, ELEVATION = 106.16



16327 LAKEVIEW DR. JERSEY VILLAGE, TX 77040




AGUIRRE & FIELDS

ENGINEERING INNOVATORS
TBPE FIRM REGISTRATION = 739

SEATTLE STREET RECONSTRUCTION PROJECT

TRAFFIC CONTROL DETAILS

APPROVED BY: CAH DRAWN BY: TJR DESIGNED: DPS DATE: 3/31/2022 SHEET: 38 OF 53

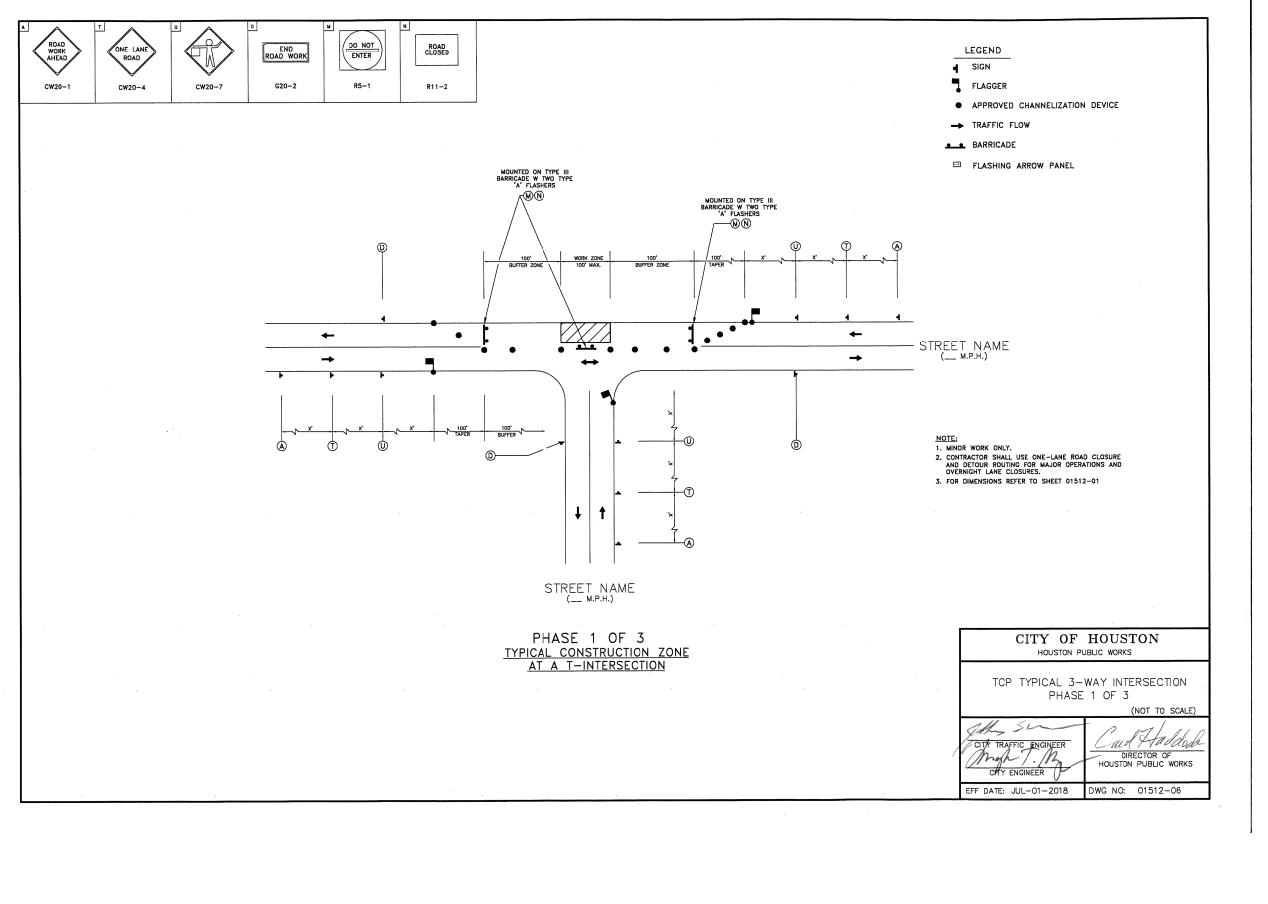

RM050425 - BRASS DISK STAMPED "050425" LOCATED AT THE NORTHEAST CORNER OF THE BRIDGE ON RIO GRANDE OVER E127-00-00 ±60' SOUTH OF VILLAGE DRIVE IN KEY MAP 409L IN THE WHITE OAK BAYOU WATERSHED. ELEVATION = 104.75' (NAVD 88, 2001 ADJ.)

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16327 LAKEVIEW DR. JERSEY VILLAGE, TX 77040




AGUIRRE & FIELDS

ENGINEERING INNOVATORS
TBPE FIRM REGISTRATION = 739

SEATTLE STREET RECONSTRUCTION PROJECT

TRAFFIC CONTROL DETAILS

DRAWN BY: TJR APPROVED BY: CAH DESIGNED: DPS DATE: 3/31/2022 SHEET: 39 OF 53

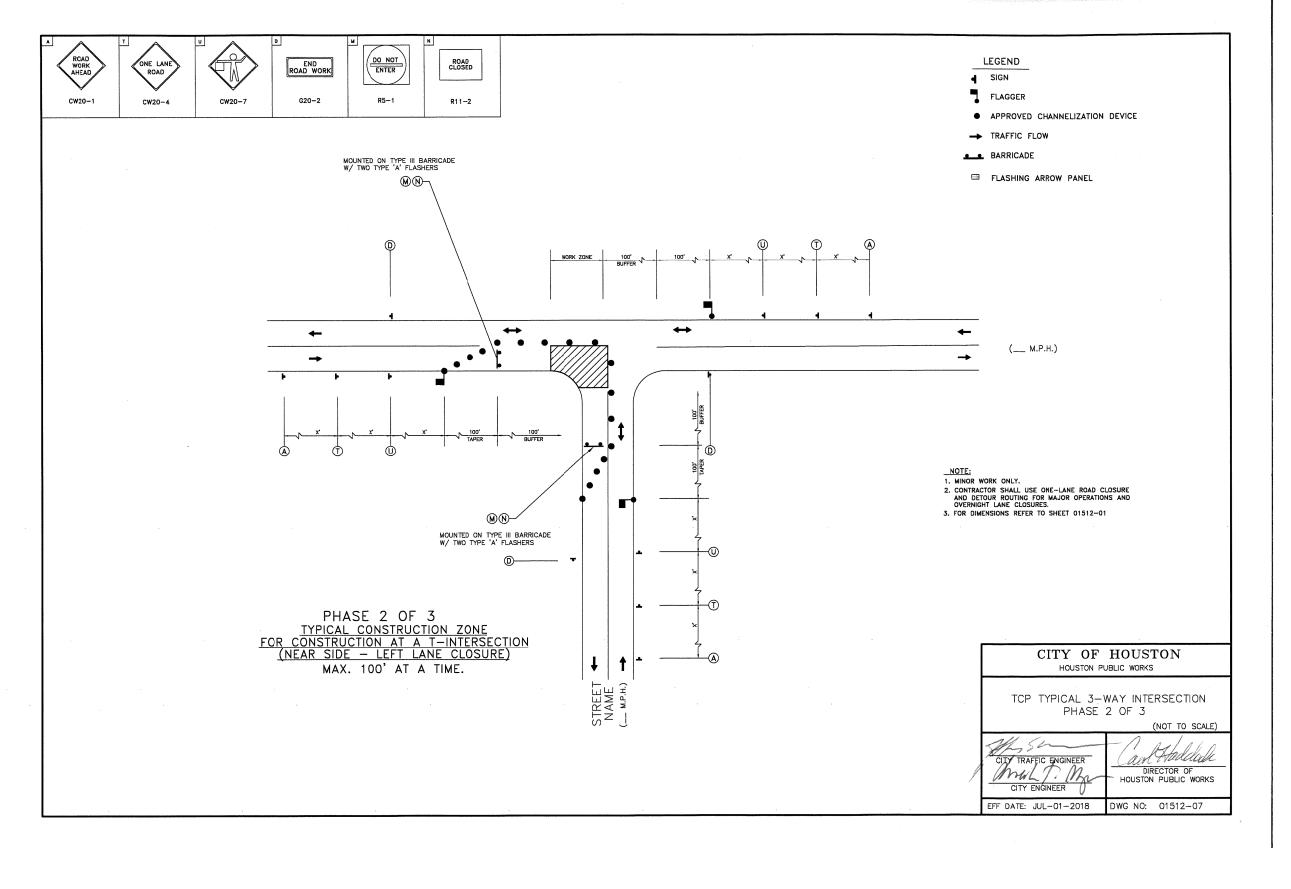

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16327 LAKEVIEW DR. JERSEY VILLAGE, TX 77040




AGUIRRE & FIELDS

ENGINEERING INNOVATORS
TBPE FIRM REGISTRATION = 739

SEATTLE STREET RECONSTRUCTION PROJECT

TRAFFIC CONTROL DETAILS

			SHEET 4 UF 6				
NO.	DATE		REVISIONS BY				
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DRAWN BY: TJR		TJR	APPROVED BY: CAH				
DES	IGNED: [)PS	DATE: 3/31/2022				
SCA	LE:		SHEET: 40 OF 53				

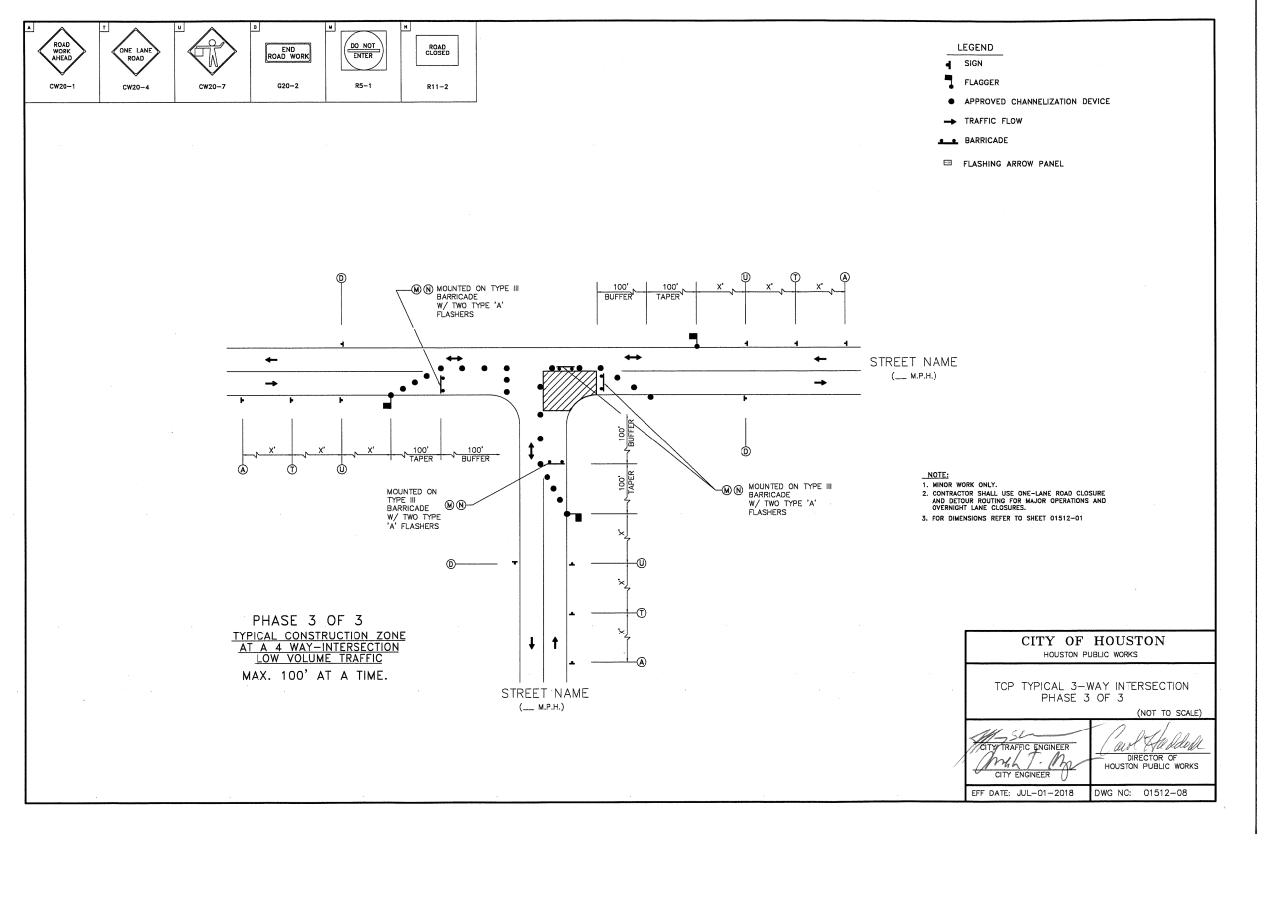

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AGUIRRE & FIELDS

ENGINEERING INNOVATORS
TBPE FIRM REGISTRATION = 739

SEATTLE STREET RECONSTRUCTION PROJECT

TRAFFIC CONTROL DETAILS

SHEET 5 OF 6

NO.	DATE	R	EVISIONS BY
DRAWN BY: TJR		TJR	APPROVED BY: CAH
DES	IGNED: [)PS	DATE: 3/31/2022
SCA	LE:		SHEET: 41 OF 53

FOR TYPE III BARRICADE FOR END OF ROAD, THE THREE (3) RAILS SHALL BE REFLECTIVE RED AND RELFLECTIVE WHITE SRIPES ON SIDE FACING TRAFFIC

18" MIN

\frac{\frac{1}{1}}\frac{1}{1}\frac{1}\frac{1}\frac{1}{1}\frac{1}{1}\frac{1}{1}\frac{1}{1}\frac{1}{1}\frac{1}{1}\frac{1}{1}\frac{1}{1}\frac{1}{1}\frac{1}{1}\frac{1}{1}\frac{1}\frac{1}{1}\frac{1}{1}\frac{1}{1}\frac{1}{1}\frac{1}{1}\frac{1}\frac{1}{1}\frac{1}{1}\frac{1}{1}\frac{1}{1}\frac{1}{1}\frac{1}{1}\frac{1}\frac{1}{1}\frac{1}{1}\frac{1}{1}\frac{1}\frac{1}{1}\frac{1}\frac{1}{1}\frac{1}\frac{1}\frac{1}\frac{1}{1}\frac{1}\fr

DRUMS, SET ON END, AND USED FOR TRAFFIC WARNING OR CHANNELIZATION SHALL BE APPROX 36" IN HEIGHT AND A MIN OF 18" IN DIAMETER. THE CONTRACTOR, AT HIS OPTION, MAY USE DRUMS MADE FROM STELL BARRELS OR BILACK POLYETHYLENE PLASTIC DRUM LINERS WEIGHING APPROX EIGHT POUNDS EACH. THE MARKINGS ON DRUMS SHALL BE HORIZONTAL, CIRCUMFERENTIAL, SETTE CONTIZED ORNOE AND REPLECTORIZED WHITE STRIPES, 4 TO 8 INCHES WIDE. THE FIRST REFLECTORIZED STRIPES SHOULD START WITHIN TWO (2) INCHES OF THE TOP OF THE DRUM. THERE SHALL BE AT LEAST TWO ORANGE AND TWO WHITE STRIPPES ON EACH DRUM. IT THERE ARE NON-REFLECTORIZED SPACES BETWEEN THE HORIZONTAL. ORANGE AND WHITE STRIPPES ON EACH DRUM. IT THERE ARE NON-REFLECTORIZED SPACES BETWEEN THE HORIZONTAL ORANGE AND WHITE STRIPPES. THEY SHALL BE NO MORE THAN 2 INCHES WIDE. METAL DRUMS SHALL BE PAINTED BLACK OR ORANGE BEFORE REFLECTORIZED STRIPPES ARE ADDED. ALL DRUMS ON PROJECT WILL BE THE SAME COLOR. WHEN DRUMS SHOULD BE USED. DURING HOURS OF DARKNESS, A FLASHING WARNING LIGHT SHOULD BE PLACED ON DRUMS USED IN SERIES FOR TRAFFIC CHANNELIZATION. DRUMS SHALL BE WEIGHTED FOR TRAFFIC CHANNELIZATION. DRUMS SHALL BE WEIGHTED WITH EACH OF THE METAL BRUMS USED IN SERIES FOR TRAFFIC CHANNELIZATION. DRUMS SHALL BE WEIGHTED WITH SAND TO THE EXTENT INDICATED IN THE PLANS.

DRUMS

FOR END OF ROAD

- 4"-8" WIDE STRIPES

AAX of Mark

CONES

CONES

TRAFFIC CONES AND TUBULAR MARKERS
SHALL BE A MIN OF 18" INCHES IN HEIGHT
WITH A BROADENED BASE AND MAY BE MADE
OF VARIOUS MATERIALS TO WITHSTAND
IN ON THE MADE
OF VARIOUS MATERIALS TO WITHSTAND
IN OF MADE AND THER POADWAYS
WHERE SEED ARCER SIZES SHOULD BE
USED ON FREEWAYS AND OTHER POADWAYS
WHERE SPEED ARE RELATIVELY HIGH OR
WHERE EVER MORE CONSPICUOUS GUIDANCE
IS NEEDED. ORANGE SHALL BE THE
PREDOMINANT COLOR ON CONES AND TUBULAR
MARKERS. THEY SHOULD BE KEPT CLEAN
AND BRIGHT FOR MAX TARGET VALUE.
FOR NICHTTIME USE THEY SHALL BE
REFLECTORIZED OR EQUIPPED WITH
LIGHTING DEVICES FOR MAX VISIBILITY.
REFLECTORIZED ME REPRIAL SHALL HAVE A
SMOOTH, SEALED OUTER SURFACE WHICH
DAY AND NIGHT.


REFLECTORIZET THE SMAE APPROX COLOR
DAY AND NIGHT.

REFLECTORIZATION OF TUBULAR MARKERS SHALL BE A MIN OF TWO THREE-INCH BANDS PLACED A MAX OF Z FROM THE TOP WITH A MAX OF Z BETWEEN THE BANDS. REFLECTORIZATION OF CONES SHALL BE PROVIDED BY A MIN 6 BAND PLACED A MAX OF Z FROM THE TOP.


CONES OR TUBULAR MARKERS ARE GENERALLY ONLY SUITABLE FOR TEMPORARY USAGE (UP TO 8 HOURS) WITH OTHER CHANNELIZATION DEVICES SUCH AS VERTICAL PANELS OR BARRICADES PREFERRED FOR LONGER TERM USAGE, CARE SHOULD BE TAKEN TO INSURE THAT THEY REMAIN IN THEIR PROPER LOCATION AND IN AN UPRIGHT POSITION.

2"X4"-


2'-0" MIN MAX IS VARIABLE V1"X10" - 2"X4"

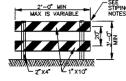

TYPE II

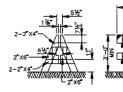

DEMOUNTABLE

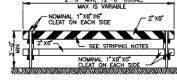




GATE FOR TYPE III BARRICADE

BARRICADES ARE TO BE CONSTRUCTED OF CLEAN SOUND MATERIAL. ALL SURFACES ABOVE GROUND, WHICH ARE NOT STRIPED, SHALL BE WHITE EXCEPT THE UNPAINTED GALVANIZED METAL OR ALUMINUM COMPONENTS MAY BE USED. COMPONENTS MAY BE USED. COMPONENTS MADE OF LUMBER SHALL BE PAINTED WITH A MINIMUM OF TWO COATS OF AN APPROVED BRAND OF WHITE PAINT TO SECURE THOROUGH COVERAGE AND A UNIFORM WHITE COLOR.


THE REFLECTORIZED WHITE AND REFLECTORIZED ORANGE (REFLECTORIZED RED) STRIPES FOR BARRICADES, DRUMS AND VERTICAL PANELS SHALL BE CONSTRUCTED OF "HIGH INTESITY SHEETING AND SHALL BE MAINTAINED TO MEET THE APPEARANCE, COLOR AND REFLECTIVITY REQUIREMENTS SET BY DOTT.

THE CONTRACTOR SHALL MAINTAIN EACH BARRICADE IN A CLEAN AND GOOD CONDITION.

12'-0" MIN OPENING

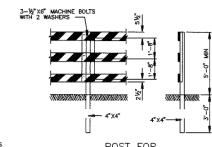

POST FOR TYPE III BARRICADE

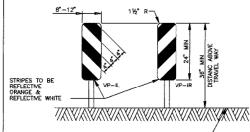

CWI-8 CHEVRON SIGNS, CWI-6A ARROW SIGNS OR VP-I VERTICAL PANELS MOUNTED ABOVE DRUMS MAY BE USED AS SUPPLEMENTS TO DRUM DELINEATION.

VERTICAL PANELS (VP)

VERTICAL PANELS (VP)
VERTICAL PANELS ARE NORMALLY USED AS CHANNELIZING DEVICES TO INDICATE TANGENT OR NEARLY TANGENT OR ROADWAY AUGMENT WHERE GOOD TARGET VAULE OF A DEVICE IS NEEDED IN DAYTIME AS WELL AS THE NIGHTTIME. IN ADDITION, VERTICAL PANELS SHOULD BE USED AT THE EDGE OF SHOULDER DROP—OFFS AND OTHER SUCH AREAS AS LANE TRANSITIONS WHERE POSITIVE DAY AND NIGHT DELINEATION MAY BE REQUIRED. VERTICAL PANELS SHOULD BE MOUNTED BACK TO BACK IF USED AT THE EDGE OF CUTS ADJACENT TO TWO—WAY TWO LANE ROADWAYS, STIRIPES SHOULD BE MOUNTED BACK TO BACK IF USED AT THE EDGE OF CUTS ADJACENT TO TWO—WAY TWO LANE ROADWAYS, STIRIPES SHOULD BE MOUNTED BACK TO BACK.

REFLECTOR UNIT (WHITE OR YELLOW) TO MATCH REQUIRED EDGELINE COLOR WAY WAY PLYWOOD FACE TO BE PAINTED CONSTRUCTION ORANGE UPRIGHT TO BE PAINTED WHITE

> TYPICAL PORTABLE VERTICAL PANEL OR DELINEATOR

OTHER SIMILAR SUPPORTS MAY BE USED WHEN APPROVED OR DIRECTED BY THE COH DEPT OF TRAFFIC AND TRANSPORTATION

STRIPING FOR BARRICADE FOR ALL TYPES OF BARRICADES WITH RAILS LESS THAN 3"-O" LONG, STRIPES 4" WIDE SHALL BE USED. IDENTIFICATION MARKINGS MAY BE SHOWN ONLY ON BACK SIDE OF BARRICADE RAILS. STRIPING SHOULD COVER THE FULL WIDTH OF THE RAIL. STRIPING OF RAILS, PANELS, ETC. SHOULD SLOPE DOWNWARD AT AN ANGLE OF 45' DEGREES IN DIRECTIONS TRAFFIC IS TO PASS.

WHERE A BARRICADE EXTENDS ENTIRELY ACROSS A ROADWAY, IT IS DESIRABLE THAT THE STRIPES SLOPE DOWNWARD IN THE DIRECTION TOWARD WHICH TRAFFIC MUST TURN IN DETOLURING. WHEN BOTH RIGHT AND LEFT TURNS ARE PROVIDED FOR, THE CHEVRON STRIPING MAY SLOPE DOWNWARD IN BOTH DIRECTIONS FROM THE CENTER OF THE BARRICADE.

CITY OF HOUSTON
DEPARTMENT OF PUBLIC WORKS AND ENGINEERING
ENGINEERING, CONSTRUCTION AND REAL ESTATE DIVISION

BARRICADE STANDARD

(NOT TO SCALE)

APPROVED BY:

DIRECTOR OF PUBLIC WORKS AND ENGINEERING EFF DATE: OCT-01-2002 DWG NO: 01580-01 REFERENCE BENCHMARK:

RM050425 - BRASS DISK STAMPED "050425" LOCATED AT THE NORTHEAST CORNER OF THE BRIDGE ON RIO GRANDE OVER E127-00-00 ±60 SOUTH OF VILLAGE DRIVE IN KEY MAP 409L IN THE WHITE OAK BAYOU WATERSHED. ELEVATION = 104.75' (NAVD 88, 2001 ADJ.)

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16327 LAKEVIEW DR. JERSEY VILLAGE, TX 77040




AGUIRRE & FIELDS ENGINEERING INNOVATOR TRPF FIRM REGISTRATION # 739


SEATTLE STREET RECONSTRUCTION PROJECT

> TRAFFIC CONTROL DETAILS

RAWN BY: TJR APPROVED BY: CAH ESIGNED: DPS DATE: 3/31/2022 SHEET: 42 OF 53

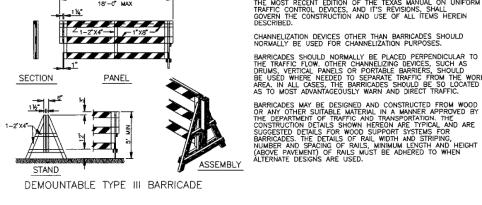


TYPE I "A" FRAME

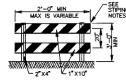

BARRICADE NOTES

THE MOST RECENT EDITION OF THE TEXAS MANUAL ON UNIFORM TRAFFIC CONTROL DEVICES, AND IT'S REVISIONS, SHALL GOVERN THE CONSTRUCTION AND USE OF ALL ITEMS HEREIN DESCRIBED.

BARRICADES SHOULD NORMALLY BE PLACED PERPENDICULAR TO THE TRAFFIC FLOW. OTHER CHANNELIZING DEVICES, SUCH AS DRUMS, VERTICAL PANELS OR PORTABLE BARRIERS, SHOULD BE USED WHERE NEEDED TO SEPARATE TRAFFIC FROM THE WORLAREA, IN ALL CASES, THE BARRICADES SHOULD BE SO LOCATED AS TO MOST ADVANTAGEOUSLY WARN AND DIRECT TRAFFIC.

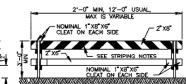

TYPE I


4'-0" MIN, 12'-0" USUAL MAX IS VARIABLE

USE 1/2" X 31/3 MACHINE BOLTS, WITH TWO WASHERS EACH

PANEL FOR


TYPE III BARRICADE

- SEE STRIPING NOTES

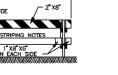






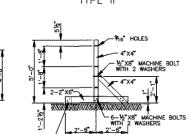

4"X6"X61/2" / BLOCK STAND FOR TYPE III BARRICADE

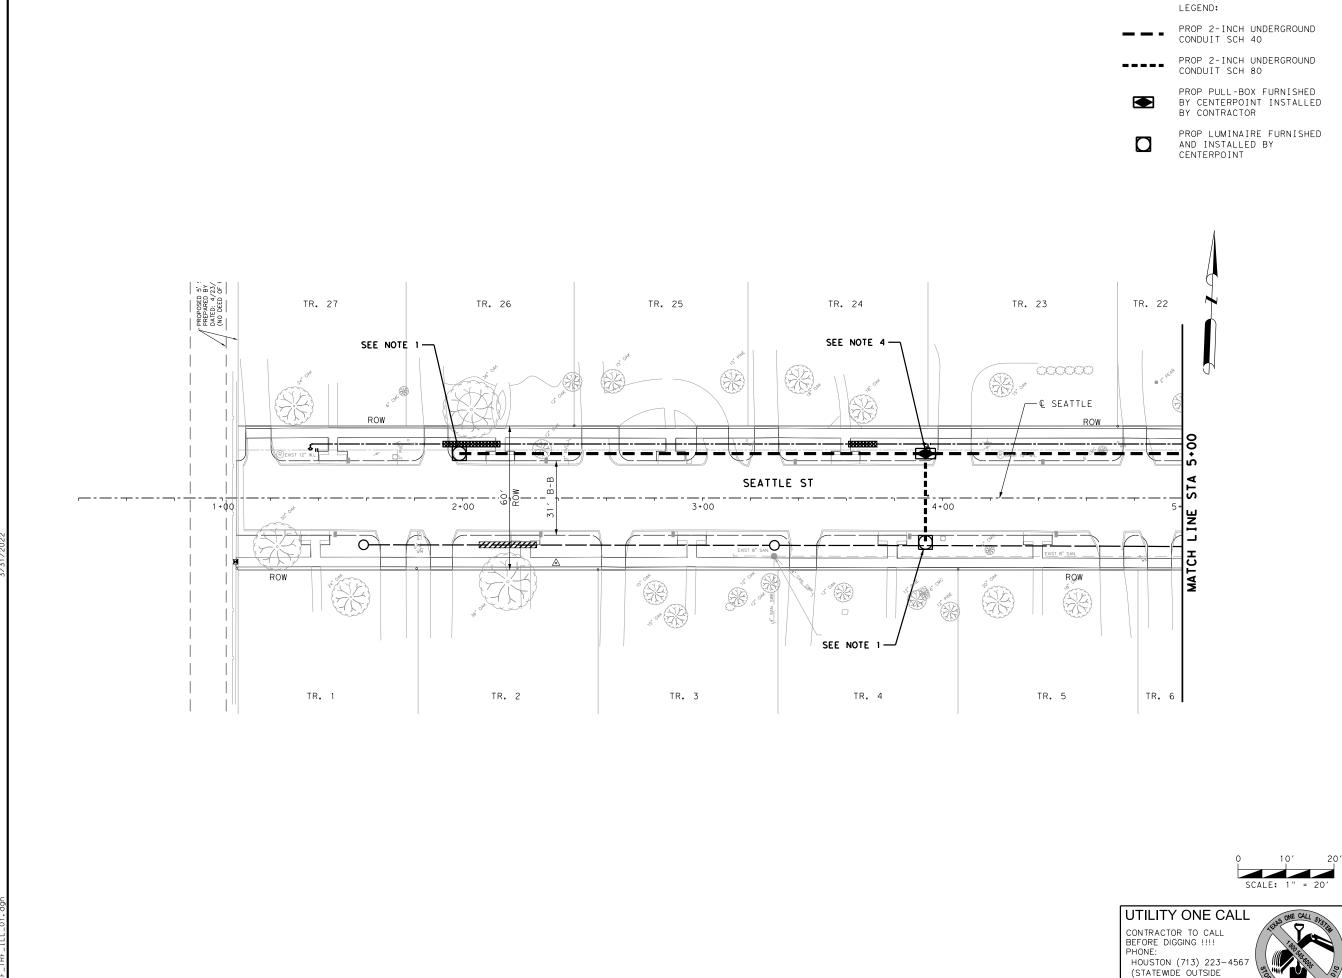

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NOTES:

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- 2. PROP PULLBOX WITH ONE (1) STUB UP.
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- PROP ONE (1) STUB UP AT EXISTING TERMINAL POLE IN SENATE AVE WEST RIGHT-OF-WAY APPROXIMATELY 160' SOUTH OF SEATTLE STREET .



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AGUIRRE & FIELDS
ENGINEERING INNOVATORS
TOPE FIRM RECISTRATION = 739


SEATTLE STREET RECONSTRUCTION PROJECT

ILLUMINATION LAYOUT BEGIN TO STA 5+00

SHEET 1 0

SHEET 1 OF						
0.	DATE	R	EVISIONS BY			
RAWN BY: TJR		TJR	APPROVED BY: CAH			
ESIGNED: DPS			DATE: 3/31/2022			
C.	LE:	·	SHEET: 43 OF 53			

HOUSTON) 1-(800)-545-6005

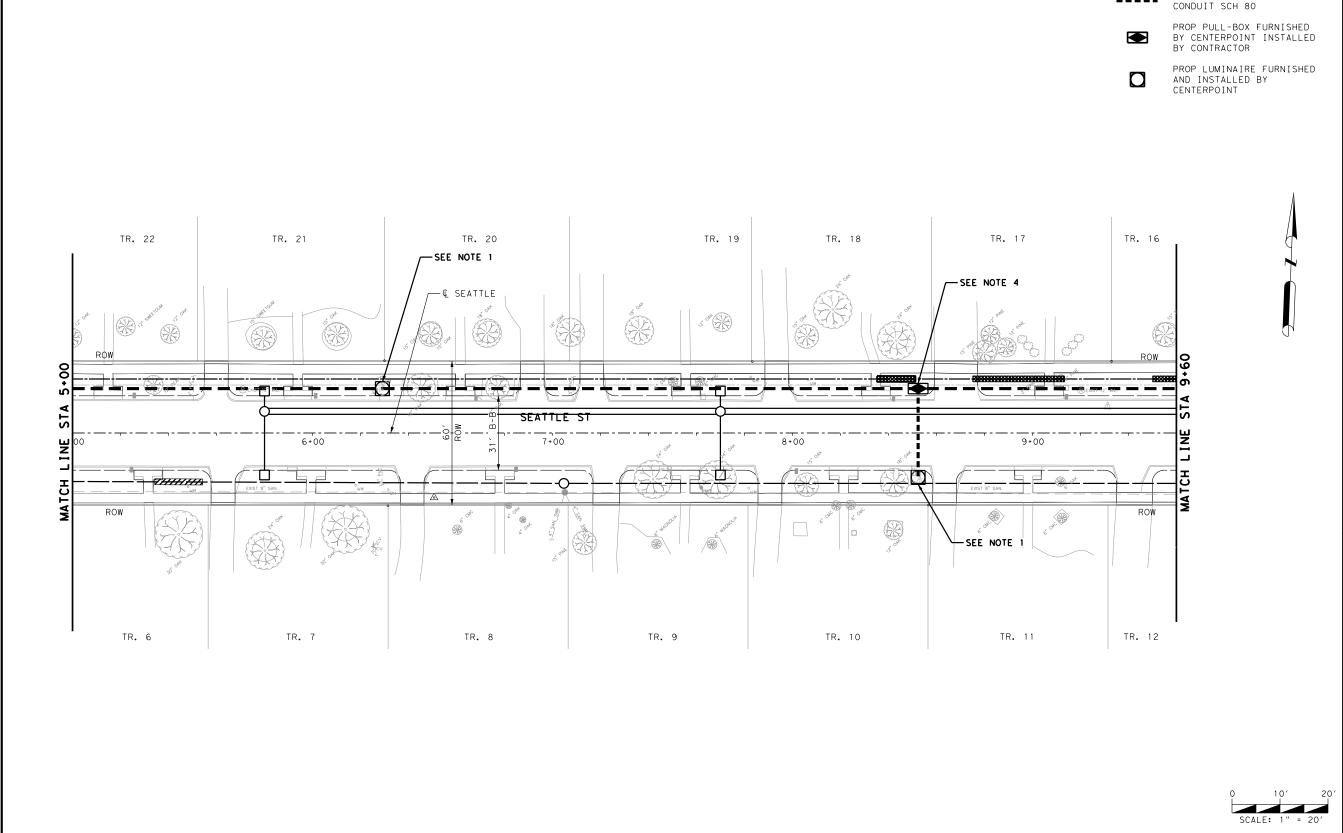

LEGEND:

UTILITY ONE CALL CONTRACTOR TO CALL BEFORE DIGGING !!!!

HOUSTON (713) 223-4567 (STATEWIDE OUTSIDE HOUSTON) 1-(800)-545-6005

PHONE:

PROP 2-INCH UNDERGROUND

PROP 2-INCH UNDERGROUND

CONDUIT SCH 40

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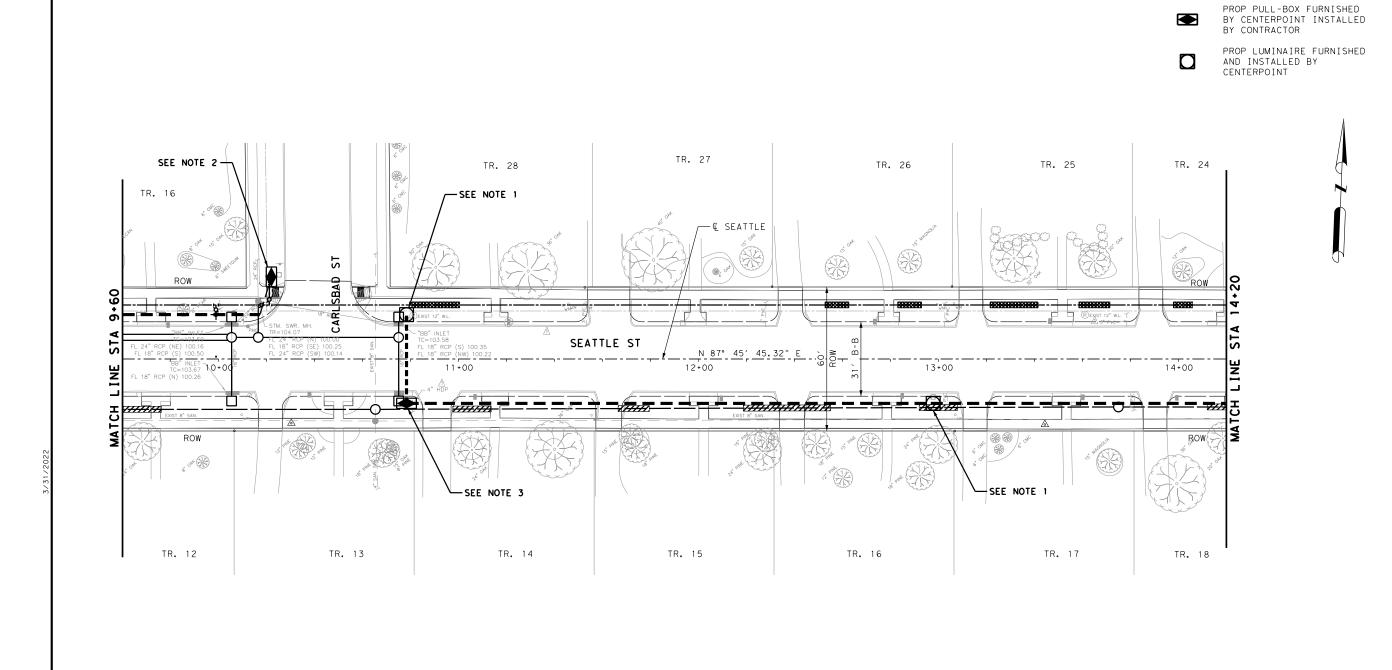


AGUIRRE & FIELDS
ENGINEERING INNOVATORS
TOPE FIRM RECISTRATION = 739

SEATTLE STREET RECONSTRUCTION PROJECT

ILLUMINATION LAYOUT STA 5+00 TO STA 9+60

	SHEET 2 OF 5					
NO.	DATE	R	EVISIONS BY			
DRAWN BY: TJR		TJR	APPROVED BY: CAH			
DESIGNED: DPS)PS	DATE: 3/31/2022			
SCALE:			SHEET: 44 OF 53			



0 10' 20 SCALE: 1" = 20'

UTILITY ONE CALL

CONTRACTOR TO CALL BEFORE DIGGING !!!! PHONE:

HOUSTON (713) 223-4567 (STATEWIDE OUTSIDE HOUSTON) 1-(800)-545-6005



REFERENCE BENCHMARK:

LEGEND:

PROP 2-INCH UNDERGROUND

PROP 2-INCH UNDERGROUND

CONDUIT SCH 40

CONDUIT SCH 80

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AGUIRRE & FIELDS


ENGINEERING INNOVATORS
TOPE FIRM REGISTRATION = 739

SEATTLE STREET RECONSTRUCTION PROJECT

ILLUMINATION LAYOUT STA 9+60 TO STA 14+20

SHEET 3 OF 5

10.	DATE	R	EVISIONS BY		
DRAWN BY: TJR		TJR	APPROVED BY: CAH		
DESIGNED: DPS)PS	DATE: 3/31/2022		
SC.	LE:		SHEET: 45 OF 53		

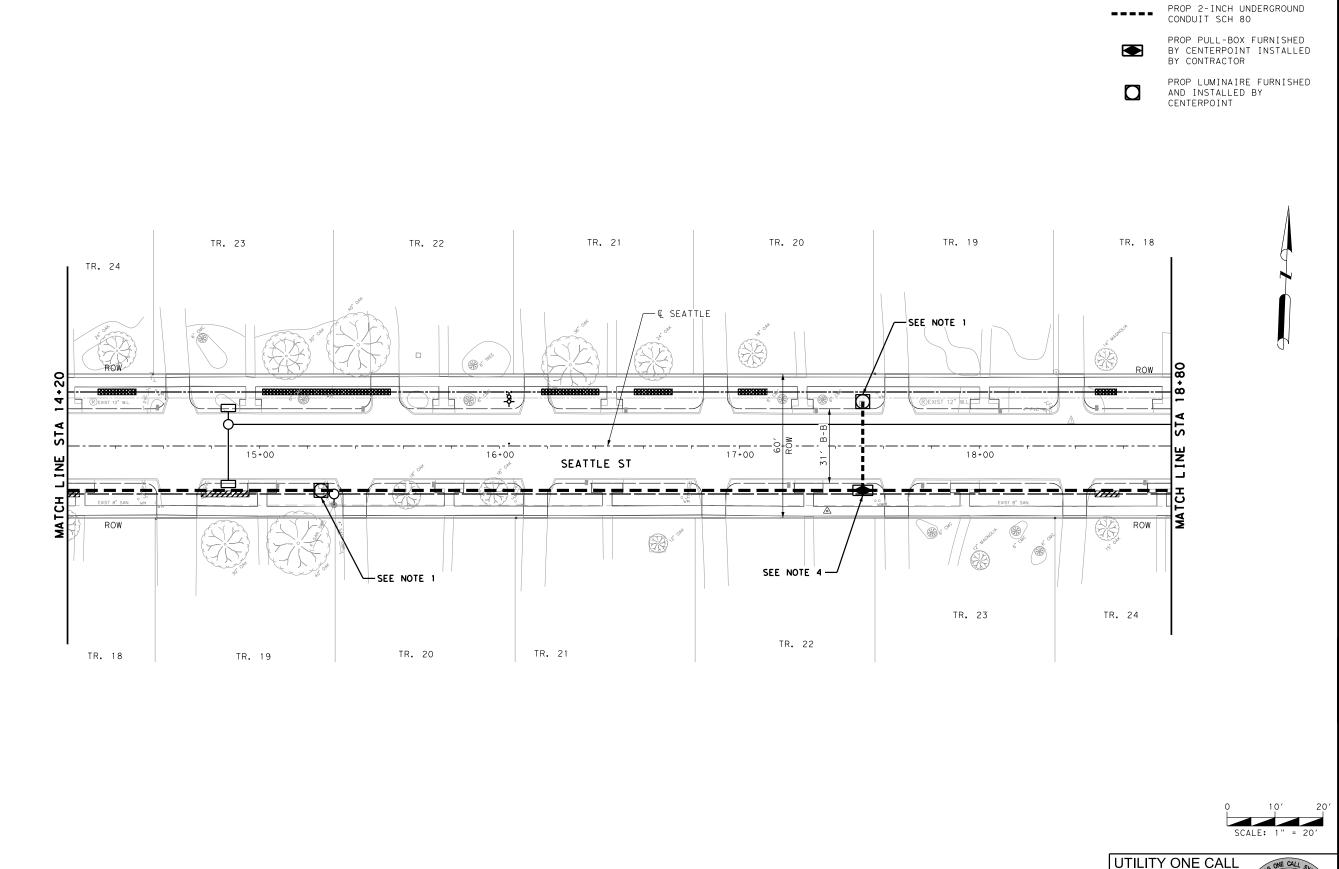

LEGEND:

CONTRACTOR TO CALL BEFORE DIGGING !!!!

HOUSTON (713) 223-4567 (STATEWIDE OUTSIDE HOUSTON) 1-(800)-545-6005

PHONE:

PROP 2-INCH UNDERGROUND

CONDUIT SCH 40

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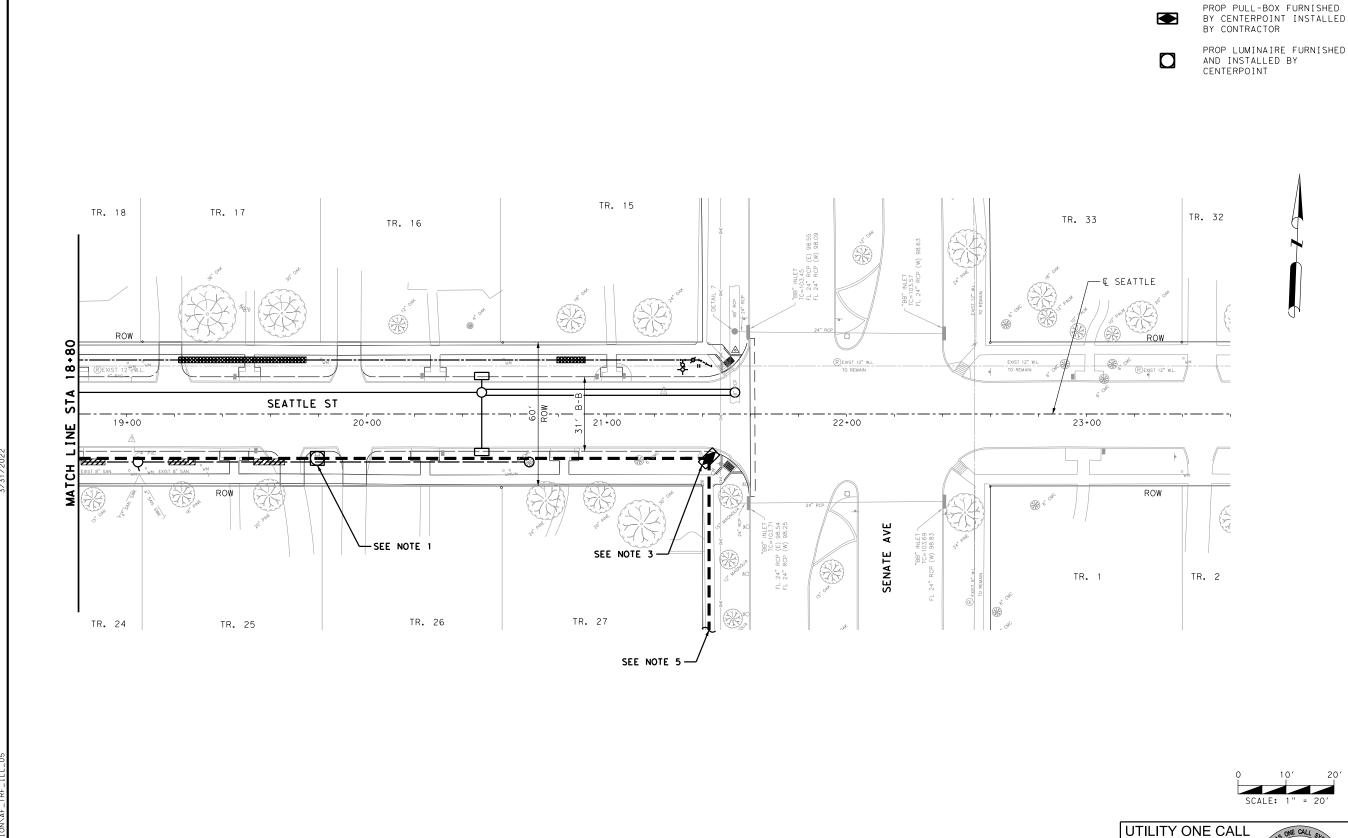


AGUIRRE & FIELDS
ENGINEERING INNOVATORS
TOPE FIRM RECISTRATION = 739

SEATTLE STREET RECONSTRUCTION PROJECT

ILLUMINATION LAYOUT STA 14+20 TO STA 18+80

NO.	DATE	R	EVISIONS E	3,
DRAWN BY: TJR		TJR	APPROVED BY: CAH	
DESIGNED: DPS)PS	DATE: 3/31/2022	
SCALE:			SHEET: 46 OF 53	



LEGEND:

CONTRACTOR TO CALL BEFORE DIGGING !!!!

HOUSTON (713) 223-4567 (STATEWIDE OUTSIDE HOUSTON) 1-(800)-545-6005

PHONE:

PROP 2-INCH UNDERGROUND

PROP 2-INCH UNDERGROUND

CONDUIT SCH 40

CONDUIT SCH 80

RM050425 - BRASS DISK STAMPED "050425" LOCATED AT THE NORTHEAST CORNER OF THE BRIDGE ON RIO GRANDE OVER E127-00-00 ±60' SOUTH OF VILLAGE DRIVE IN KEY MAP 409L IN THE WHITE OAK BAYOU WATERSHED. ELEVATION = 104.75' (NAVD 88, 2001 ADJ.)

TEMPORARY BENCHMARKS:

TBM "A" - BOX CUT ON "BB" INLET LOCATED AT THE NORTHWEST CORNER OF SEATTLE STREET AND SENATE AVENUE. ELEVATION = 103.44′

TBM "B" - BOX CUT ON "BB" INLET LOCATED AT THE SOUTHWEST CORNER OF SEATTLE STREET AND CARLSBAD STREET. ELEVATION = 103.68'

TBM "C" - BOX CUT ON THE END OF THE CONCRETE SIDEWALK AT THE SOUND WALL LOCATED ON THE SOUTH SIDE OF SEATTLE STREET. ELEVATION = 106.16'

NOTES:

- 1. PROP 45W LED LUMINAIRE ON 17' POLE (INSTALLED BY CENTERPOINT).
- 2. PROP PULLBOX WITH ONE (1) STUB UP.
- 3. PROP PULLBOX WITH TWO (2) STUB UPS.
- 4. PROP PULLBOX WITH THREE (3) STUB UPS
 - PROP ONE (1) STUB UP AT EXISTING TERMINAL POLE IN SENATE AVE WEST RIGHT-OF-WAY APPROXIMATELY 160' SOUTH OF SEATTLE STREET .



16327 LAKEVIEW DR. JERSEY VILLAGE, TX 77040




AGUIRRE & FIELDS
ENGINEERING INNOVATORS
TOPE FIRM RECISTRATION = 739


SEATTLE STREET RECONSTRUCTION PROJECT

ILLUMINATION LAYOUT STA 18+80 TO END

SHEET 5 (

0.	DATE	R	VISIONS BY
RAWN BY: TJR		TJR	APPROVED BY: CAH
ESIGNED: DPS)PS	DATE: 3/31/2022
CA	LE:		SHEET: 47 OF 53

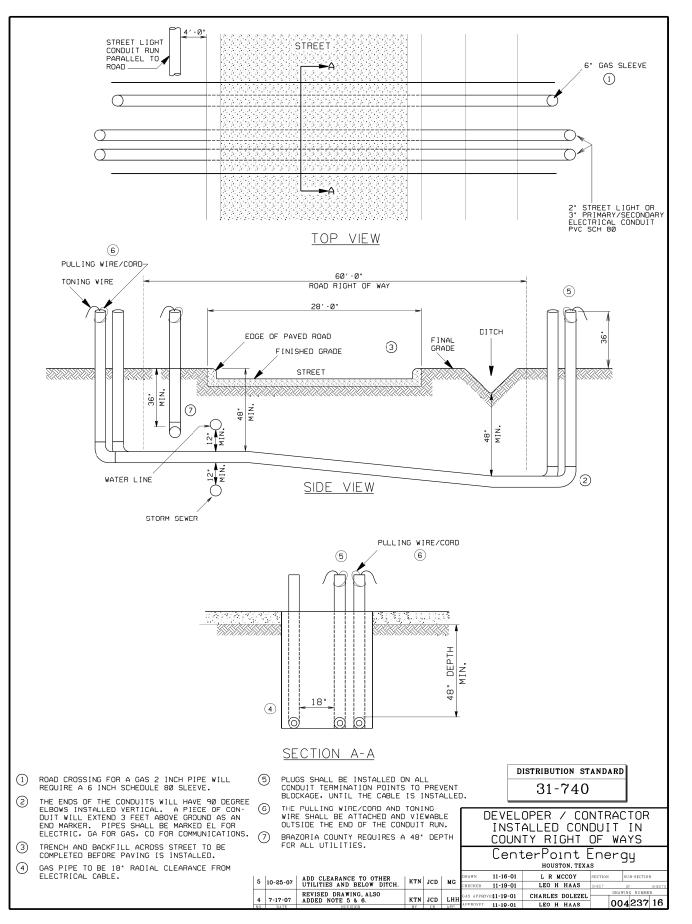

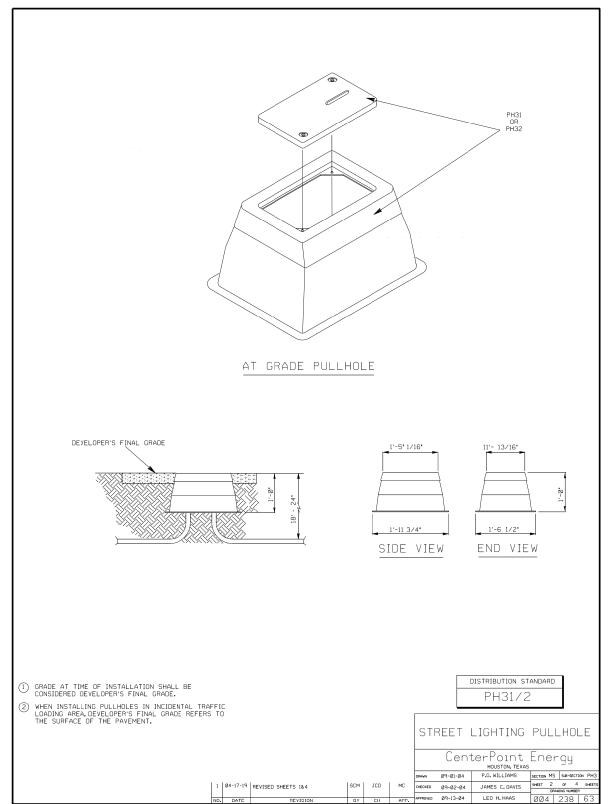

RM050425 - BRASS DISK STAMPED "050425" LOCATED AT THE NORTHEAST CORNER OF THE BRIDGE ON RIO GRANDE OVER E127-00-00 ±60' SOUTH OF VILLAGE DRIVE IN KEY MAP 409L IN THE WHITE OAK BAYOU WATERSHED. ELEVATION = 104.75' (NAVD 88, 2001 ADJ.)

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16327 LAKEVIEW DR. JERSEY VILLAGE, TX 77040




AGUIRRE & FIELDS
ENGINEERING INNOVATORS
TOPE FIRM REGISTRATION = 739

SEATTLE STREET
RECONSTRUCTION PROJECT

ILLUMINATION DETAILS

SHEET 1 OF 2

10.	DATE	R	EVISIONS BY
ORA	WN BY:	TJR	APPROVED BY: CAH
DES	IGNED: [)PS	DATE: 3/31/2022
SCALE:			SHEET: 48 OF 53

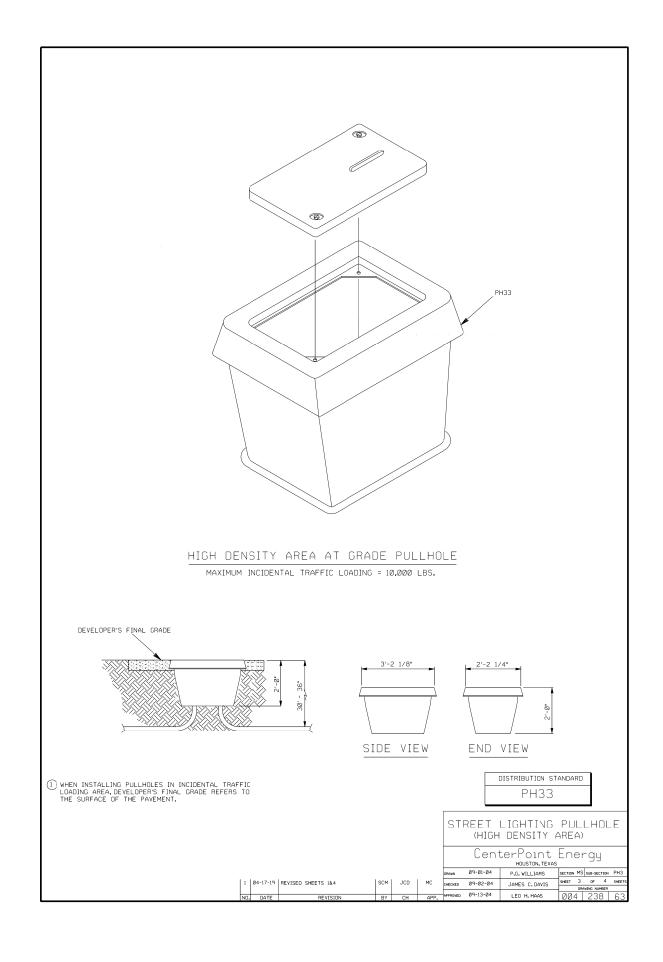

PU: PH3XX: STREET LIGHTING PULLHOLE FOR STANDARDS PH3

STREET LIGHT PULLHOLE-XX: STREET LIGHTING PULLHOLE, VARIABLE

PH31: STREET LIGHT, PULL HOLE, GRASSY AREA PH32: STREET LIGHT, PULL HOLE, INCIDENTAL TRAFFIC AREA PH33: STREET LIGHT, PULL HOLE, HIGH DENSITY AREA

	S	SU NAM CU QT		
PH3XX	PH31	PH32	PH33	
CU NAME	(CU QT	/	
ACCOUNT – 373				
PH31	1	-	-	
PH32	-	1	-	
PH33	-	-	1	
ACCOUNT - 367				
ANT-POISON	1	1	1	

SU NAME	CU NAME	PART#	PART DESCRIPTION	PART QTY
PH31	PH31	107895	PEDESTAL, LIGHT, STREET	1
	ANT-POISON	134649	INSECTICIDE, 5% DURSBAN, GRANUL	1
PH32	PH32	107900	PULL HOLE, SL,11"W X 18"L X 12"D, 20K LID	1
	ANT-POISON	134649	INSECTICIDE, 5% DURSBAN, GRANUL	1
PH33	PH33	107946	PULL HOLE, SL,4"W X 36"L X 4"D, 20K LID	1
	ANT-POISON	134649	INSECTICIDE, 5% DURSBAN, GRANUL	1

04-17-19 UPDATED TO DDS LAYOUT

SCM JCD MC

DISTRIBUTION STANDARD PH3XX

	STREET LIGHTING PULLHOLES Center Point Ener gy HOUSTON, TX					
	DRAWN 09-01-04	P.G. WILLIAMS	SECTION MS		SUB-SECTION PH3	
	CHECKED 09-02-04	JAMES C. DAVIS		SHEET 4 OF 4 SHEETS DRAWING NUMBER		
	APPROVED 09-13-04	LEO H. HAAS	004	238	63	

REFERENCE BENCHMARK:

RM050425 - BRASS DISK STAMPED "050425" LOCATED AT THE NORTHEAST CORNER OF THE BRIDGE ON RIO GRANDE OVER E127-00-00 ±60' SOUTH OF VILLAGE DRIVE IN KEY MAP 409L IN THE WHITE OAK BAYOU WATERSHED. ELEVATION = 104.75' (NAVD 88, 2001 ADJ.)

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16327 LAKEVIEW DR. JERSEY VILLAGE, TX 77040



AGUIRRE & FIELDS


ENGINEERING INNOVATORS

TOPE FIRM REGISTRATION = 739

SEATTLE STREET RECONSTRUCTION PROJECT

ILLUMINATION DETAILS

	SHEET X OF X				
	DATE REVISIONS			BY	
_	<u> </u>				
AWN BY: TJR			APPROVED BY: CAH		
SIGNED: DPS			DATE: 3/31/2022		
ALE:			SHEET: 4/9 OF 5/3		

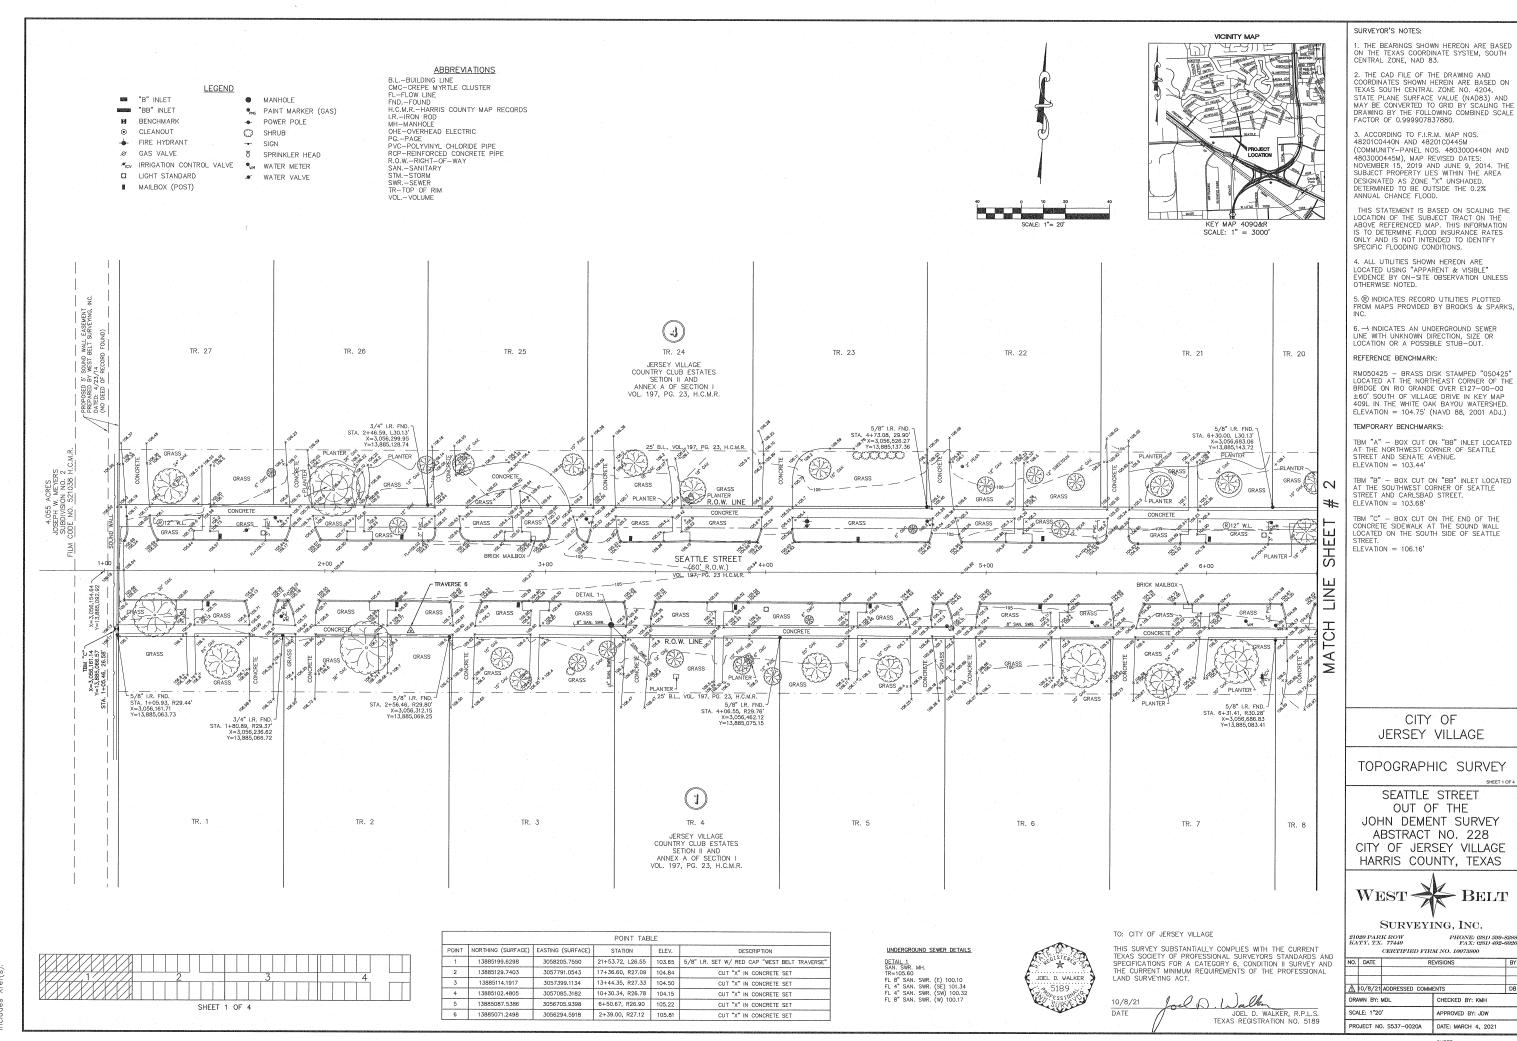

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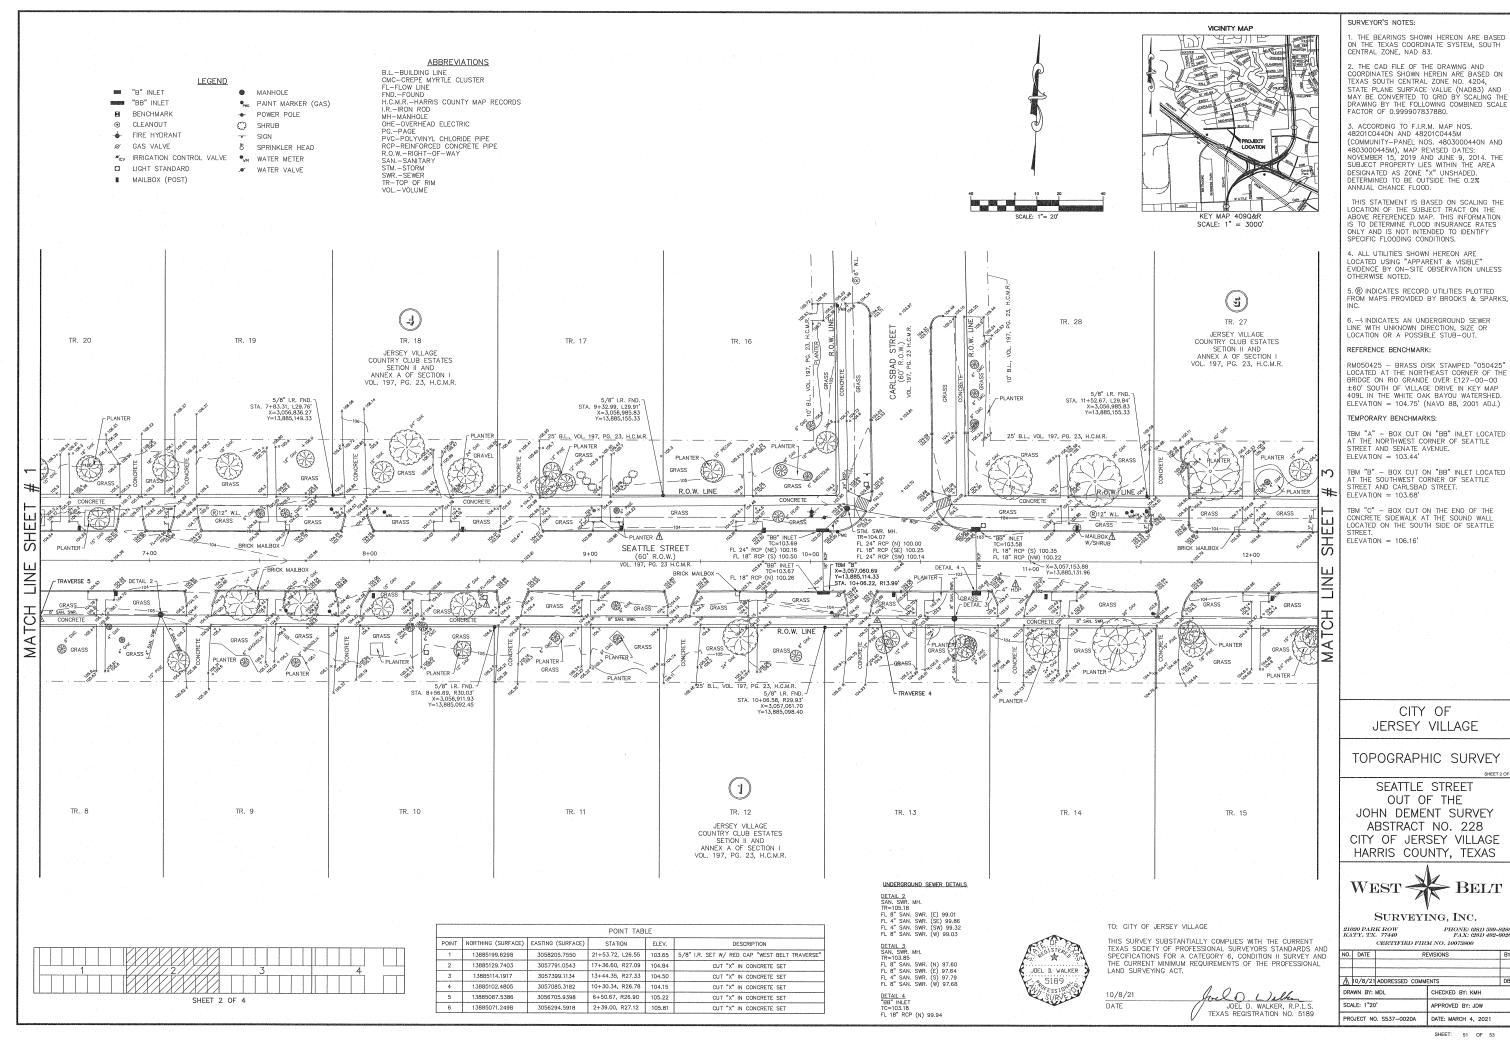
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50 OF 53

APPROVED BY: JDW


REVISIONS

CITY OF



CHECKED BY: KMH

REVISIONS

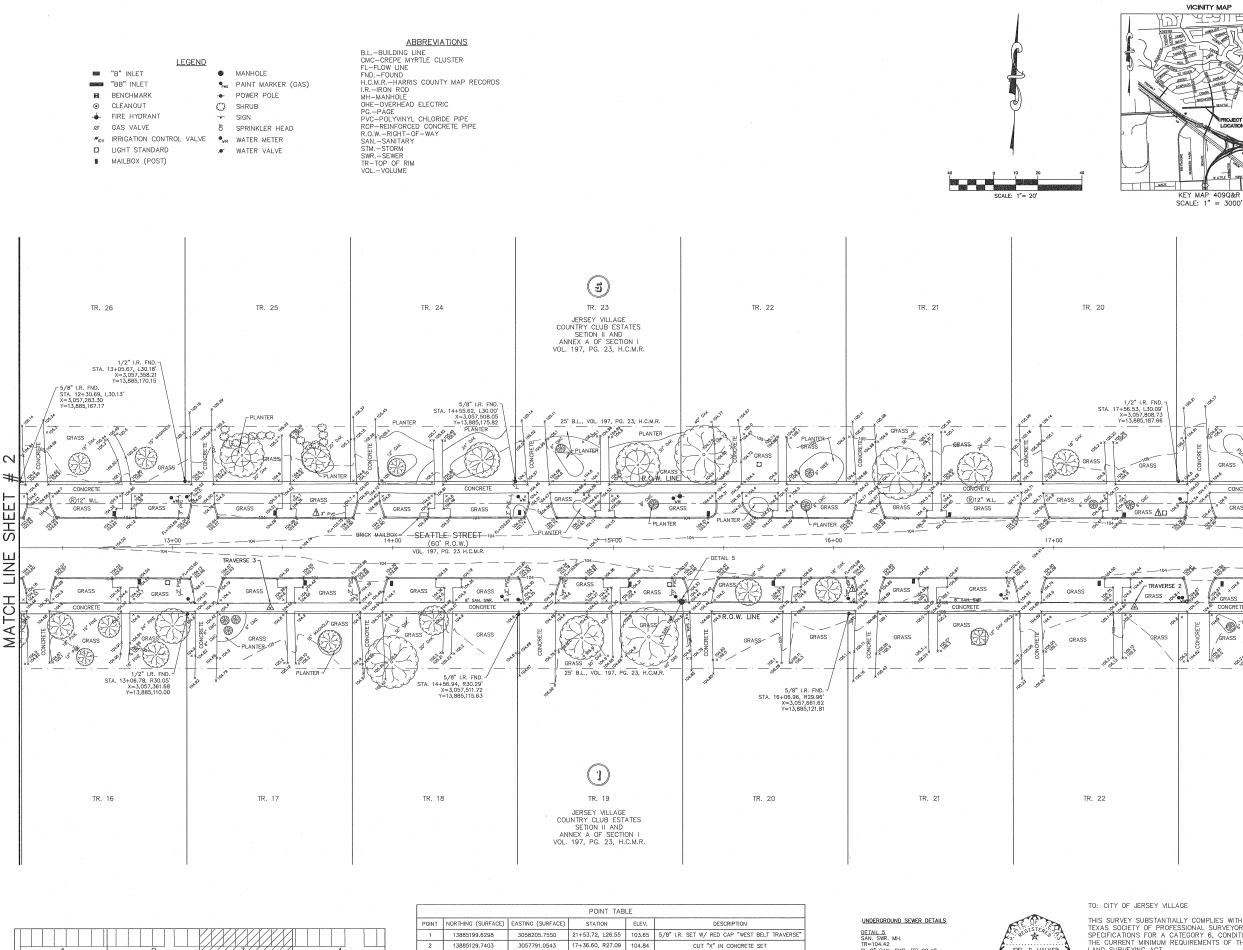

3+44.35, R27.33 104.50

CUT "X" IN CONCRETE SET

CUT "X" IN CONCRETE SET

CUT "X" IN CONCRETE SET

10+30.34, R26.78 104.15

6+50.67, R26.90 105.22

2+39.00, R27.12 105.81

3057085.3182

3056705.9398

3056294.5918

SURVEYOR'S NOTES:

1. THE BEARINGS SHOWN HEREON ARE BASED ON THE TEXAS COORDINATE SYSTEM, SOUTH CENTRAL ZONE, NAD 83.

2. THE CAD FILE OF THE DRAWING AND COORDINATES SHOWN HEREIN ARE BASED ON TEXAS SOUTH CENTRAL ZONE NO. 4204, STATE PLANE SUFFACE VALUE (NADB3) AND MAY BE CONVERTED TO GRID BY SCALING THE DRAWING BY THE FOLLOWING COMBINED SCALE FACTOR OF 0.999907837880.

3. ACCORDING TO F.I.R.M. MAP NOS. 48201C0440N AND 48201C0445M (COMMUNITY-PANEL NOS. 4803000440N AND (COMMONITY-MANIEL NOS. 4803000440N AND 4803000444N), MAP REVISED DATES: NOVEMBER 15, 2019 AND JUNE 9, 2014. THE SUBJECT PROPERTY LIES WITHIN THE AREA DESIGNATED AS ZONE "X" UNSHADED. DETERMINED TO BE OUTSIDE THE 0.2% ANNUAL CHANCE FLOOD.

THIS STATEMENT IS BASED ON SCALING THE LOCATION OF THE SUBJECT TRACT ON THE ABOVE REFERENCED MAP. THIS INFORMATION IS TO DETERMINE FLOOD INSURANCE RATES ONLY AND IS NOT INTENDED TO IDENTIFY SPECIFIC FLOODING CONDITIONS.

4. ALL UTILITIES SHOWN HEREON ARE LOCATED USING "APPARENT & VISIBLE" EVIDENCE BY ON-SITE OBSERVATION UNLESS OTHERWISE NOTED.

5. ® INDICATES RECORD UTILITIES PLOTTED FROM MAPS PROVIDED BY BROOKS & SPARKS, INC.

6. — INDICATES AN UNDERGROUND SEWER LINE WITH UNKNOWN DIRECTION, SIZE OR LOCATION OR A POSSIBLE STUB-OUT.

REFERENCE BENCHMARK:

TR. 19

18+00

1

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ELEVATION = 106.16'

CITY OF JERSEY VILLAGE

TOPOGRAPHIC SURVEY

SEATTLE STREET

OUT OF THE JOHN DEMENT SURVEY ABSTRACT NO. 228 CITY OF JERSEY VILLAGE HARRIS COUNTY, TEXAS



21020 PARK ROW KATY, TX. 77449

PHONE: (281) 599-82 FAX: (281) 492-60

CHECKED BY: KMH SCALE: 1"20' APPROVED BY: JDW PROJECT NO. S537-0020A DATE: MARCH 4, 202

52 OF 53

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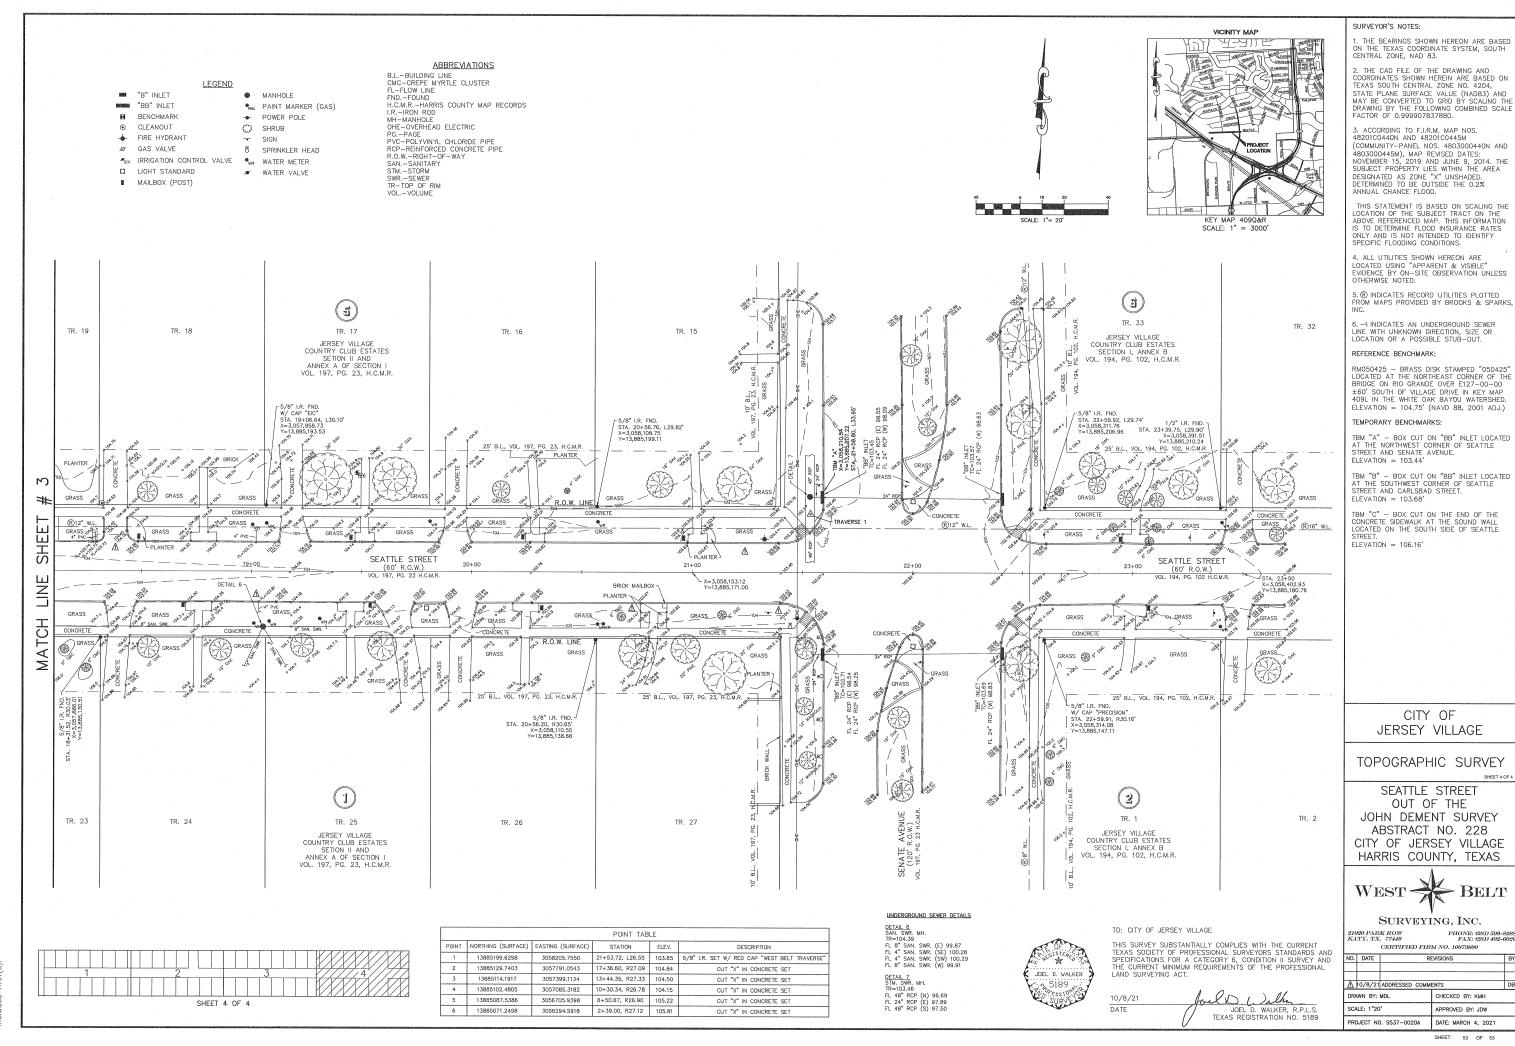
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oct sdsk Jdes

SAN. SWR. MH.
TR=104.42
FL. 8" SAN. SWR. (E) 98.48
FL. 4" SAN. SWR. (SE) 98.92
FL 4" SAN. SWR. (SW) 98.87
FL. 8" SAN. SWR. (W) 98.49

THIS SURVEY SUBSTANTIALLY COMPLIES WITH THE CURRENT TEXAS SOCIETY OF PROFESSIONAL SURVEYORS STANDARDS AND SPECIFICATIONS FOR A CATEGORY 6, CONDITION II SURVEY AND THE CURRENT MINIMUM REQUIREMENTS OF THE PROFESSIONAL LAND SURVEYING ACT.

foelD. L Inlhe 10/8/21 JOEL D. WALKER, R.P.L.S. TEXAS REGISTRATION NO. 5189



CHECKED BY: KMH

PROVED BY: JDW

BELT

REVISIONS

PHONE: (281) 599-85 FAX: (281) 492-60

CITY OF